

#### CITY OF WEST KELOWNA DEVELOPMENT VARIANCE PERMIT DVP 23-08

To: Kelly Doell 2506 Tallus Heights Lane West Kelowna, BC V4T 3M2

- 1. This permit type is issued subject to compliance with all the Bylaws of the City of West Kelowna applicable thereto, except as specifically varied or supplemented by this Permit.
- 2. This Permit applies to and only to those lands within the City of West Kelowna described below, and any and all buildings, structures, and other developments thereon:

# PLAN EPP123596 LOT 39 DISTRICT LOT 2600 OSOYOOS DIV OF YALE DISTRICT 2516 PINNACLE RIDGE DR

- 3. This Permit allows for the variance of S.3.18.2 of Zoning Bylaw No. 0265 to increase the maximum gross floor area of a secondary suite from 1076 ft² to 1432 ft² and is subject to the following conditions and related Schedules:
  - A. The size and dimensions of the secondary suite are to be in accordance with Schedule 'A';
  - B. The dimensions, siting, and parking layout are to be in accordance with Schedule 'B':
- 4. The land described herein shall be developed strictly in accordance with the terms and conditions of this Permit and any plans and specifications attached to this Permit, which shall form a part hereof. Should any change be required to this permit, please ensure that you obtain written approval from the City of West Kelowna prior to making any changes.
- 5. If this Development Permit has not been issued within one year from approval, Permit (DVP 23-08) shall be deemed to have been refused and the file will be closed.
- 6. This Permit is not a Building Permit.
- 7. This Permit is not a Municipal Highway Permit.
- 8. This is not an Archaeology Permit.

A: All archaeological sites in B.C. are protected under the Heritage Conservation Act. This applies to whether sites are located on public or private land and whether the site is known or unknown. If you think you have uncovered an archaeological site during a building project or renovation, please do not disturb the site further and call B.C.'s Archaeology Branch

immediately at (250) 953-3334. Branch archaeologists will review your project plans and make recommendations to manage site impacts and secure the required permitting.

AUTHORIZING RESOLUTION NO (XXXXXXX) PASS (DATE).	SED BY THE MUNICIPAL COUNCIL ON
	Signed on
	Corporate Officer
I hereby confirm that I have read and concur with the cand will ensure that copies of the Permit will be a construction.	•
	Signed on
	Property Owner or Agent
ISSUED on	
Schedules:	
Schedule A: Architectural Plans prepared by Exciting F	Home Plans on December 7 <sup>th</sup> , 2022.
Schedule B: Site Plan prepared by Exciting Home Plan	ns on August 30 <sup>th</sup> , 2023.





# The Tran Residence

Project # A1611

# **GENERAL NOTES**

- IT IS THE RESPONSIBILITY OF THE CLIENT AND/OR THEIR BUILDER AGENT TO CHECK ALL LOCAL BYLAW AND CODE REQUIREMENTS, SITE AND SOIL CONDITIONS AND ENSURE THEY ARE MET.

· ALL LOCAL BYLAW AND CODE REQUIREMENTS MUST BE MET, AND ANY SPECIFICATIONS NOTED IN THESE DRAWINGS MUST BE ALTERED BY THE CLIENT AND/OR HIS AGENT BUILDER TO MEET THOSE CODES IF AND WHEN NECESSARY.

· IF SOIL CONDITIONS WARRANT, CONCRETE FOUNDATION AND FOOTING SIZING AND SPECIFICATIONS MUST BE CALCULATED BY A LOCAL ENGINEER OR ENGINEERS REGISTERED

CONCRETE FOOTING DEPTHS AND SIZES MUST MEET LOCAL CLIMATE, CODE AND LOCAL BYLAW REQUIREMENTS.

· CONCRETE TYPE MUST MEET SOIL CONDITIONS AND ALL LOCAL BYLAW AND CODE REQUIREMENTS PERTAINING TO FOUNDATION MATERIALS MUST BE MET.

PROFESSIONALS AND ENGINEERS REQUIRED TO COMPLETE THESE TASKS MAY OR MAY NOT INCLUDE: STRUCTURAL ENGINEER FOR FOUNDATION DESIGN AND SPECIFICATIONS,

- GEOTECHNICAL ENGINEER FOR SOIL TESTING AND SPECIFICATIONS.

- LOCAL ARCHITECT REGISTERED TO DO RESIDENTIAL CALCULATIONS.

EVERY EFFORT HAS BEEN MADE TO ENSURE THAT THESE CONSTRUCTION DRAWINGS ARE FREE OF ERRORS.

IT IS THE RESPOSIBILITY OF THE CONTRACTOR OR THE CONTRACTORS AGENTS TO CHECK AND VERIFY ALL DIMENSIONS AND MATERIALS SIZES AND DEFINITIONS LISTED ON THESE DRAWINGS. THE BUILDING CONTRACTOR IS RESPONSIBLE FOR UNDERSTANDING AND APPLYING PROPER BUILDING PRACTICES.

THE DESIGNER SHALL NOT BE HELD LIABLE FOR ANY ERRORS, OMISSIONS, OR DEFICIENCIES IN ANY FORM BY ANY PARTY WHATSOEVER.

THERE ARE NO PRODUCT ENDORSEMENTS IMPLIED FOR ANY OF THE MATERIALS LISTED ON THESE DRAWINGS.

PROPER INSTALLATION OF CONSTRUCTION ASSEMBLIES INCLUDING NAILING, GLUING, CAULKING, INSULATING, FLASHING, ROOFING, WEATHERPROOFING AND MANY OTHER SMALL ITEMS AND DETAILS ARE NOT NECESSARILY IDENTIFIED OR NOTED ON THE PLANS. THE DESIGNER HAS NO CONTROL OR RESPONSIBILITY OVER THESE ITEMS.

#### **GENERAL SITE NOTES:**

ALL PERSONS ON SITE MUST WEAR HARD HATS AND PROPER FOOTWEAR. BUILDER MUST TAKE CARE THAT ALL WALLS IN CONSTRUCTION ARE BRACED

ALL EXCITING HOME PLANS ARE COPYRIGHT PROTECTED BY THE DESIGNERS. EXCITING HOME PLANS DESIGNS ARE SOLD ON A "ONE PLAN PURCHASE FOR ONE HOUSE BUILT" BASIS. ANY REPRODUCTION OR COPYING FOR THE INTENTION OF BVUILDING MULTIPLE HOMES IS AN INFRINGEMENT OF COPYRIGHT. PLEASE CONTACT EXCITING HOME PLANS FOR FURTHER DETAILS.

BUILDER MUST TAKE CARE TO PLACE TEMPORARY RAILINGS AROUND OPENINGS IN FLOORS AND CEILINGS.

BUILDER MUST TAKE CARE THAT SITE IS PROPERLY BLOCKED OFF AND MARKED "CONSTRUCTION SITE"

#### **CONCRETE NOTES:**

UNLESS OTHERWISE NOTED, THE COMPRESSIVE STRENGTH FOR UNREINFORCED CONCRETE AFTER 28 DAYS SHALL NOT BE LESS THAN 32 MPa FOR GARAGE AND CARPORT FLOOR & ALL EXTERIOR FLATWORK, 20MPa WHERE REQUIRED BY TABLE 9.15.4.1 FOR FOUNDATON WALLS & 15MPa FOR ALL OTHER APPLICATIONS.

#### **FOOTING NOTES:**

20MPa CONC. STRIP FOOTINGS SHALL BE PLACED ON UNDISTURBED SOIL CAPABLE OF BEARING 3000 PSF LOAD.

BOTTOM OF FOOTINGS TO BE AT OR BELOW FROST LINE DESIGNATED BY LOCAL BYLAWS OR CODE.

STEPPED FOOTINGS TO BE PROVIDED (WHERE REQURIED BY GRADE) TO BE STEPPED MAX. 24" RISE AND MIN. 24" HORIZONTAL, UNLESS OTHERWISE SPECIFIED.

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4" PERFORATED PLASTIC FOUNDATION DRAIN PIPE (TIED INTO SUMP WHERE REQ'D) - COVERED WITH 6" CLEAR STONE & FILTER CLOTH, IN LINE WITH BTM IF FTGS. AT PERIMETER OF BLDG. MIN. 1/4" PARGING (EXTERIOR) TO 12" BELOW GRADE.

**LUMBER NOTES:** 

LOCAL BUILDING CODE

CHECK ALL TOP OF WINDOW ROUGH OPENING HEIGHTS PRIOR TO FRAMING. ACTUAL DIMENSIONS OF ROUGH OPENINGS VARY DEPENDING ON MANUFACTURER. ALL WINDOW SIZES, TYPES, AND OPENERS TO BE CHECKED BY CONTRACTOR PRIOR TO ORDERING TAKE CARE TO CHECK LOCAL BUILDING CODE FOR GLASS REGULATIONS SUCH AS TEMPERED GLASS, EGRESS LOCATIONS AND LIMITATIONS ON THE SIZE OF UNPROTECTED OPENINGS NEXT TO NEIGHBORING BUILDINGS PRIOR TO ORDERING. ALL WINDOWS TO MEET ENERGY RATING OF 17ER FOR OPERATING WINDOWS & 27ER FOR FIXED

**GENERAL CONSTRUCTION NOTES** 

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(SEMI-F) NOTE ON BEAMS INDICATES A PARTIALLY DROPPED BEAM TO ALLOW FOR

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NOTE ON BEAMS INDICATES A DROPPED, MEANING THE BEAM IS PLACED UNDER

IMPACTED OPENINGS, OR TO ALLOW HEATING DUCTS TO PASS OVER. SEE DETAIL.

"LOAD BEARING POST" AT BEAM ENDS OR OTHER LOAD BEARING POINTS. REQUIRES

STUDS TO BE NAILED TOGETHER TO FORM A STRUCTURAL POST (4X4,6X6,4X6).

ALL LUMBER TO BE GRADE STAMPED, LABELLED OR OTHERWISE IDENTIFIED, AS REQUIRED BY

ALL WINDOW & DOOR MEASUREMENTS ARE IN FEET & INCHES. (5040 INDICATES 5'-0" x 4'-0")

**BEAM AND STRUCTURAL DESIGN NOTES:** 

THE SUPPORTED STRUCTURE.

**STRUCTURAL POST NOTES:** 

**WINDOW & DOOR NOTES:** 

WINDOWS PER CAN/CSA-A440-2. EXTERIOR DOORS TO BE METAL INSULATED OR SOLID CORE WOOD DOORS, W/

WEATHERSTRIPPING. NOTES ON DESIGN ELEMENTS EXCEEDING CODE REQUIREMENTS:

\*\* - MATERIALS OR ASSEMBLY CONSTRUCTION MATERIALS SHOWN, AND/OR NOTED \*\* MAY OR MAY NOT BE REQUIRED BY LOCAL CODE, BUT ARE CONSIDERED GOOD BUILDING PRACTICE. BUILDING CONTRACTOR IS RESPONSIBLE TO CONSULT BOTH THE LOCAL CODE REQUIREMENTS, AND THE HOME OWNER REGARDING PLACEMENT OF THESE MATERIALS OR ASSEMBLIES.

# **ENGINEERED WOOD PRODUCTS NOTES:**

CITY OF WEST KELOWNA

ENGINEERED WOOD SUPPLIER/TRUSS MFR. TO PROVIDE ENGINEERED DRAWINGS, SEALED BY A P.ENG. LICENSED TO PRACTICE IN THIS HOMEPLAN'S BUILDING LOCATION, FOR THE BUILDING INSPECTOR TO REVIEW ON SITE.

#### **FLOOR JOIST SYSTEM NOTES:**

ENGINEERED JOISTS (TJI) FLOOR SYSTEMS ARE ASSUMED ON THESE DRAWINGS. JOIST SPANS AND JOIST DEPTHS MAY VARY DEPENDING ON THE MANUFACTURER. IF DIMENSIONAL LUMBER JOISTS ARE USED, CALCULATIONS MUST MEET LOCAL CODES FOR LOAD BEARING, SIZE AND SPACING.

CONTRACTOR MUST TAKE CARE THAT ALL BLOCKING, STRAPPING AND BRACING IS COMPLETED PER MANUFACTURERS SPECIFICATIONS AND DRAWINGS.

#### **ROOF DESIGN & CONSTRUCTION NOTES:**

NOTES TO ROOF MANUFACTURERS

- ROOF DESIGNER TO CONSIDER DIMENSIONAL LUMBER FOR BEAMS NOTED "ENG. BEAM" AND SUBSTITUTE WHERE STRUCTURALLY POSSIBLE BY CODE. - TRUSS HEELS IN ALL APPLICATIONS MUST HAVE A MINIMUM 8" HEEL FOR INSULATION PURPOSES.

- CONTRACTOR MUST TAKE CARE THAT ALL BLOCKING, STRAPPING AND BRACING IS COMPLETED PER MANUFACTURERS SPECIFICATIONS AND DRAWINGS. - CONTRACTOR IS TO ENSURE G.I. FLASHINGS ARE PLACED IN ALL ROOF VALLEYS

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Project # A1343 - Lot 11 Ph 9 Tallus

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Kelowna

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Tallus Ridge Ph. 11

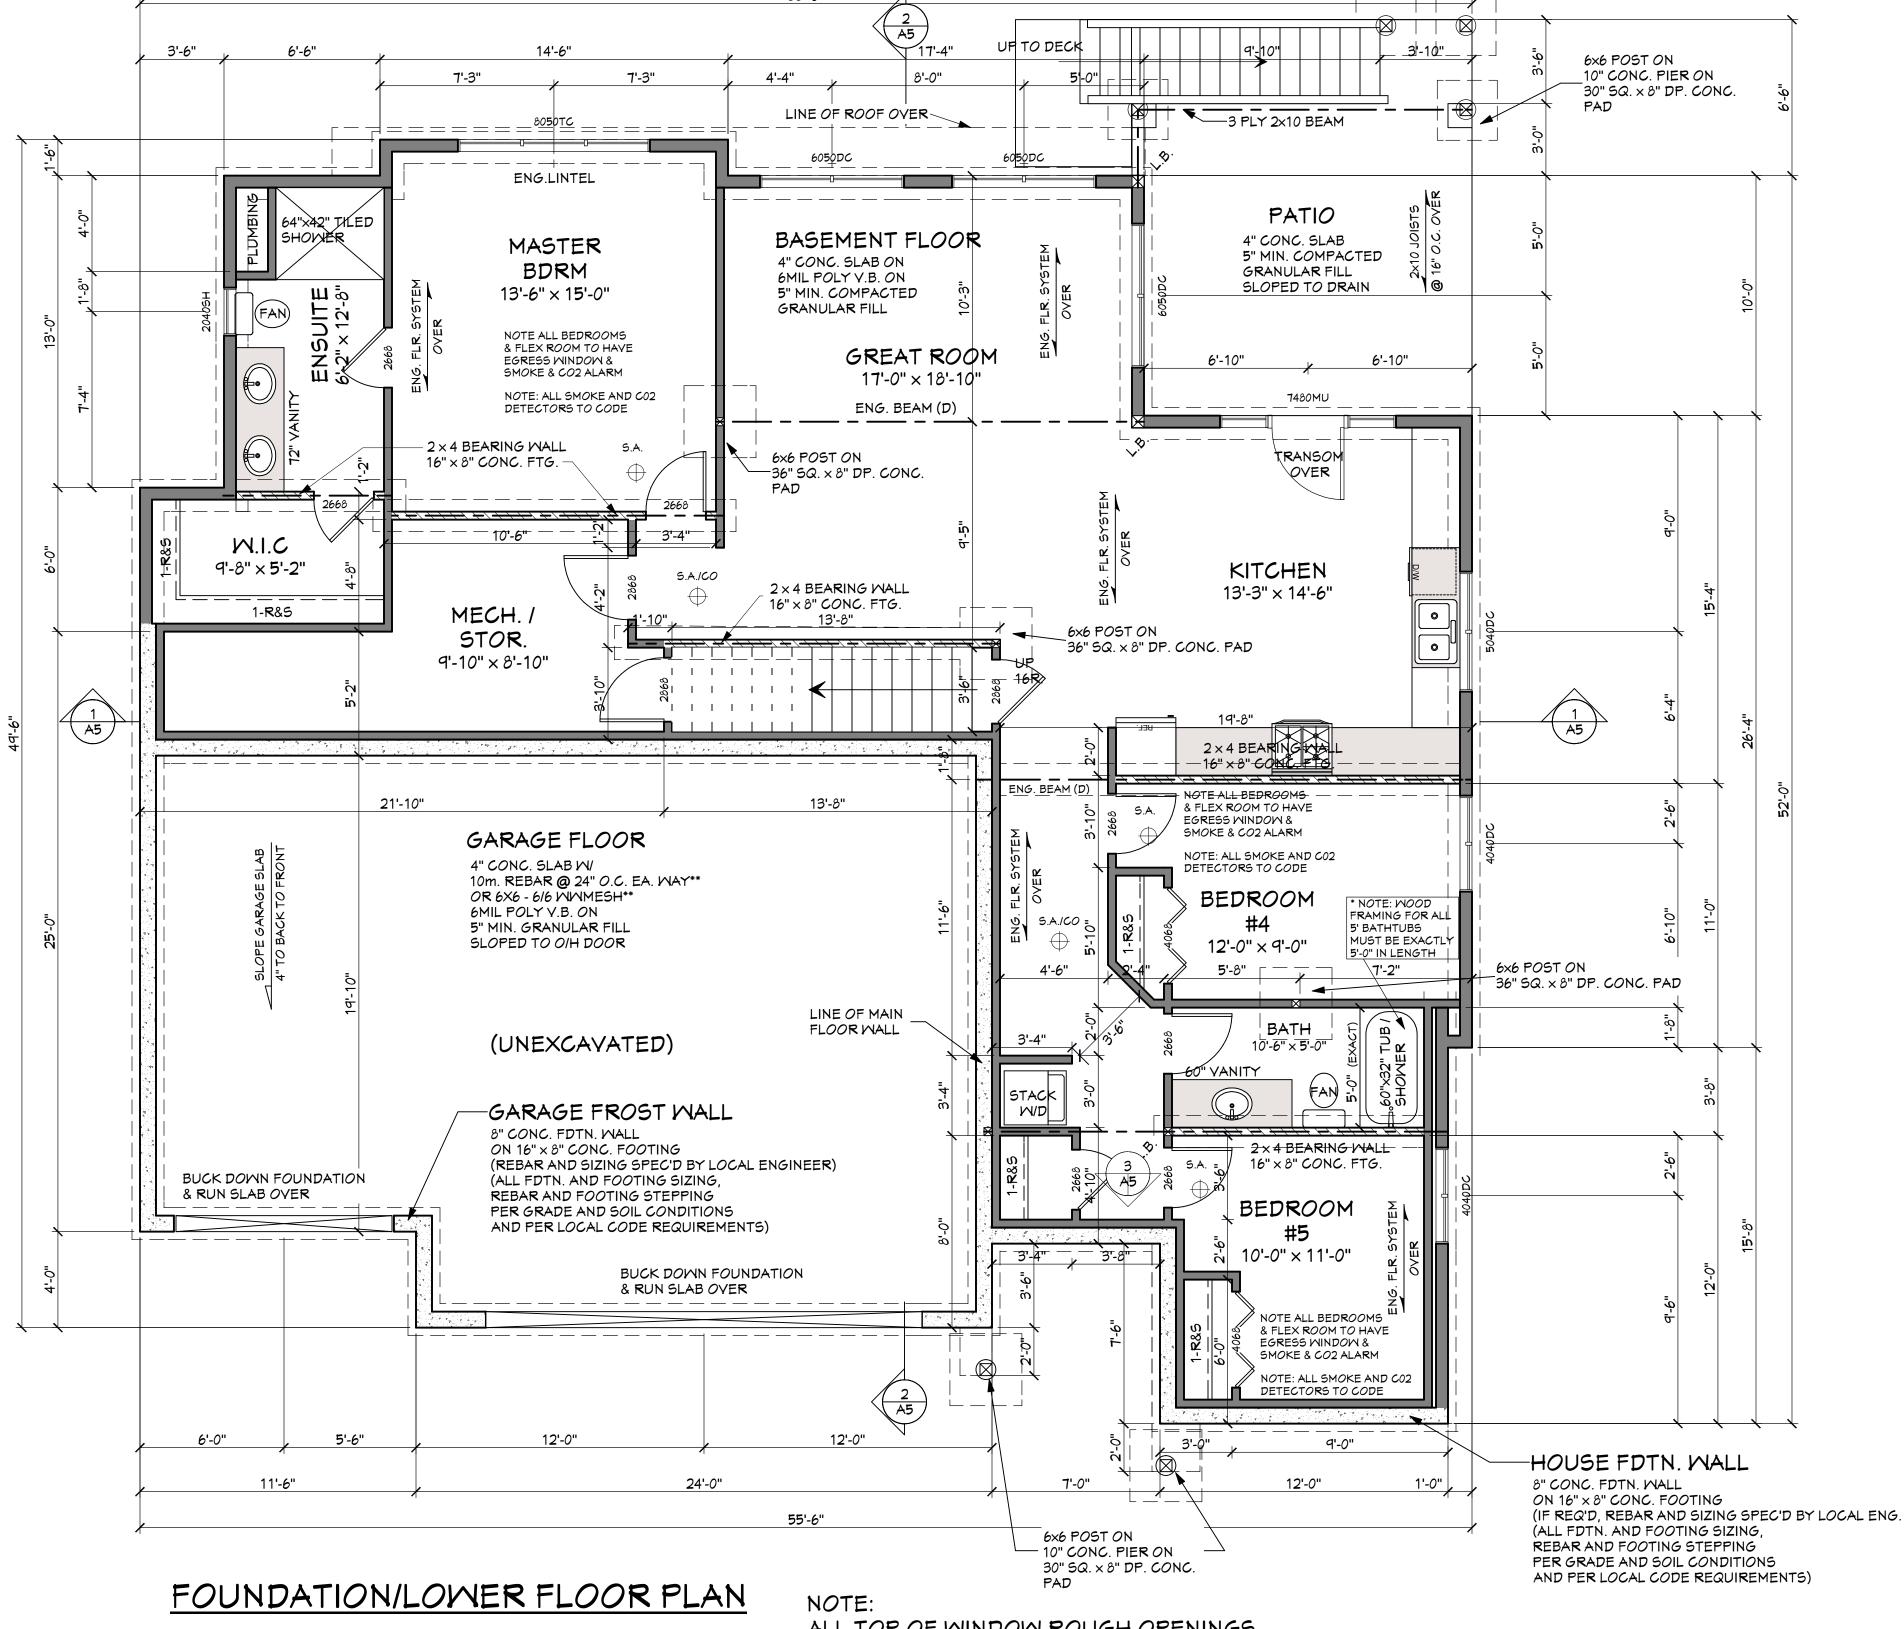
Client: The Tran Residence

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JOB# SCALE 1/4'' = 1'-0'DRAWN BY GES CHECKED GES



9' CEILING HEIGHT UNLESS NOTED OTHERWISE FINISHED FLOOR AREA = 1432 SQ.FT. UNFINISHED AREA = 145 SQ.FT.

ALL TOP OF WINDOW ROUGH OPENINGS TO BE 96" ABOYE FLOOR SURFACE.

# **FOUNDATION NOTES**

### **CONCRETE NOTES:**

UNLESS OTHERWISE NOTED, THE COMPRESSIVE STRENGTH FOR UNREINFORCED CONCRETE AFTER 28 DAYS SHALL NOT BE LESS THAN 32 MPa FOR GARAGE AND CARPORT FLOOR & ALL EXTERIOR FLATWORK, 20MPa WHERE REQUIRED BY TABLE 9.15.4.1 FOR FOUNDATON WALLS & 15MPa FOR ALL OTHER APPLICATIONS. **FOOTING NOTES:** 

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MIN. 1/4" PARGING (EXTERIOR) TO 12" BELOW GRADE.

#### **STRUCTURAL POST NOTES:**

(LB) "LOAD BEARING POST" AT BEAM ENDS OR OTHER LOAD BEARING POINTS. REQUIRES STUDS TO BE NAILED TOGETHER TO FORM A STRUCTURAL POST (4X4,6X6,4X6).

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# **GENERAL NOTES**

# **BEAM AND STRUCTURAL DESIGN NOTES:**

- NOTE ON BEAMS DESIGNATES FLUSH, MEANING EITHER THE TOP OR BOTTOM OF THE BEAM TO NOT PROTRUDE PAST FINISHED PLANE.
- NOTE ON BEAMS INDICATES A DROPPED, MEANING THE BEAM IS PLACED UNDER THE SUPPORTED STRUCTURE.
- (SEMI-F) NOTE ON BEAMS INDICATES A PARTIALLY DROPPED BEAM TO ALLOW FOR IMPACTED OPENINGS, OR TO ALLOW HEATING DUCTS TO PASS OVER. SEE DETAIL.

#### **INTERIOR BEARING WALLS:**

UNDER ENG. FLOOR SYSTEMS: ALL OPENINGS IN INTERIOR BEARING WALLS ARE TO BE CONSTRUCTED WITH STRUCTURAL LINTELS PER FLOOR SUPPLIERS SPECIFICATIONS. UNDER DIMENSIONAL LUMBER FLOORS: SEE LOCAL CODE FOR RESIDENTIAL BEAM SPAN LOAD CALCULATIONS.

# **LUMBER NOTES:**

ALL LUMBER TO BE GRADE STAMPED, LABELLED OR OTHERWISE IDENTIFIED, AS REQUIRED BY LOCAL BUILDING CODE

### **WINDOW & DOOR NOTES:**

ALL WINDOW & DOOR MEASUREMENTS ARE IN FEET & INCHES. (5040 INDICATES 5'-0" x 4'-0") CHECK ALL TOP OF WINDOW ROUGH OPENING HEIGHTS PRIOR TO FRAMING. ACTUAL DIMENSIONS OF ROUGH OPENINGS VARY DEPENDING ON MANUFACTURER. ALL WINDOW SIZES, TYPES, AND OPENERS TO BE CHECKED BY CONTRACTOR PRIOR TO ORDERING. TAKE CARE TO CHECK LOCAL BUILDING CODE FOR GLASS REGULATIONS SUCH AS TEMPERED GLASS, EGRESS LOCATIONS AND LIMITATIONS ON THE SIZE OF UNPROTECTED OPENINGS NEXT TO NEIGHBORING BUILDINGS PRIOR TO ORDERING.

ALL WINDOWS TO MEET ENERGY RATING OF 17ER FOR OPERATING WINDOWS & 27ER FOR FIXED WINDOWS PER CAN/CSA-A440-2.

EXTERIOR DOORS TO BE METAL INSULATED OR SOLID CORE WOOD DOORS, W/ WEATHERSTRIPPING.

Project # A1343 - Lot 11 Ph 9 Tallus

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2022-12-07

Tallus Ridge Ph. 11

The Tran Residence

DRAWING TITLE:

**BASEMENT** 

FOUNDATION /

MAIN FLOOR PLAN

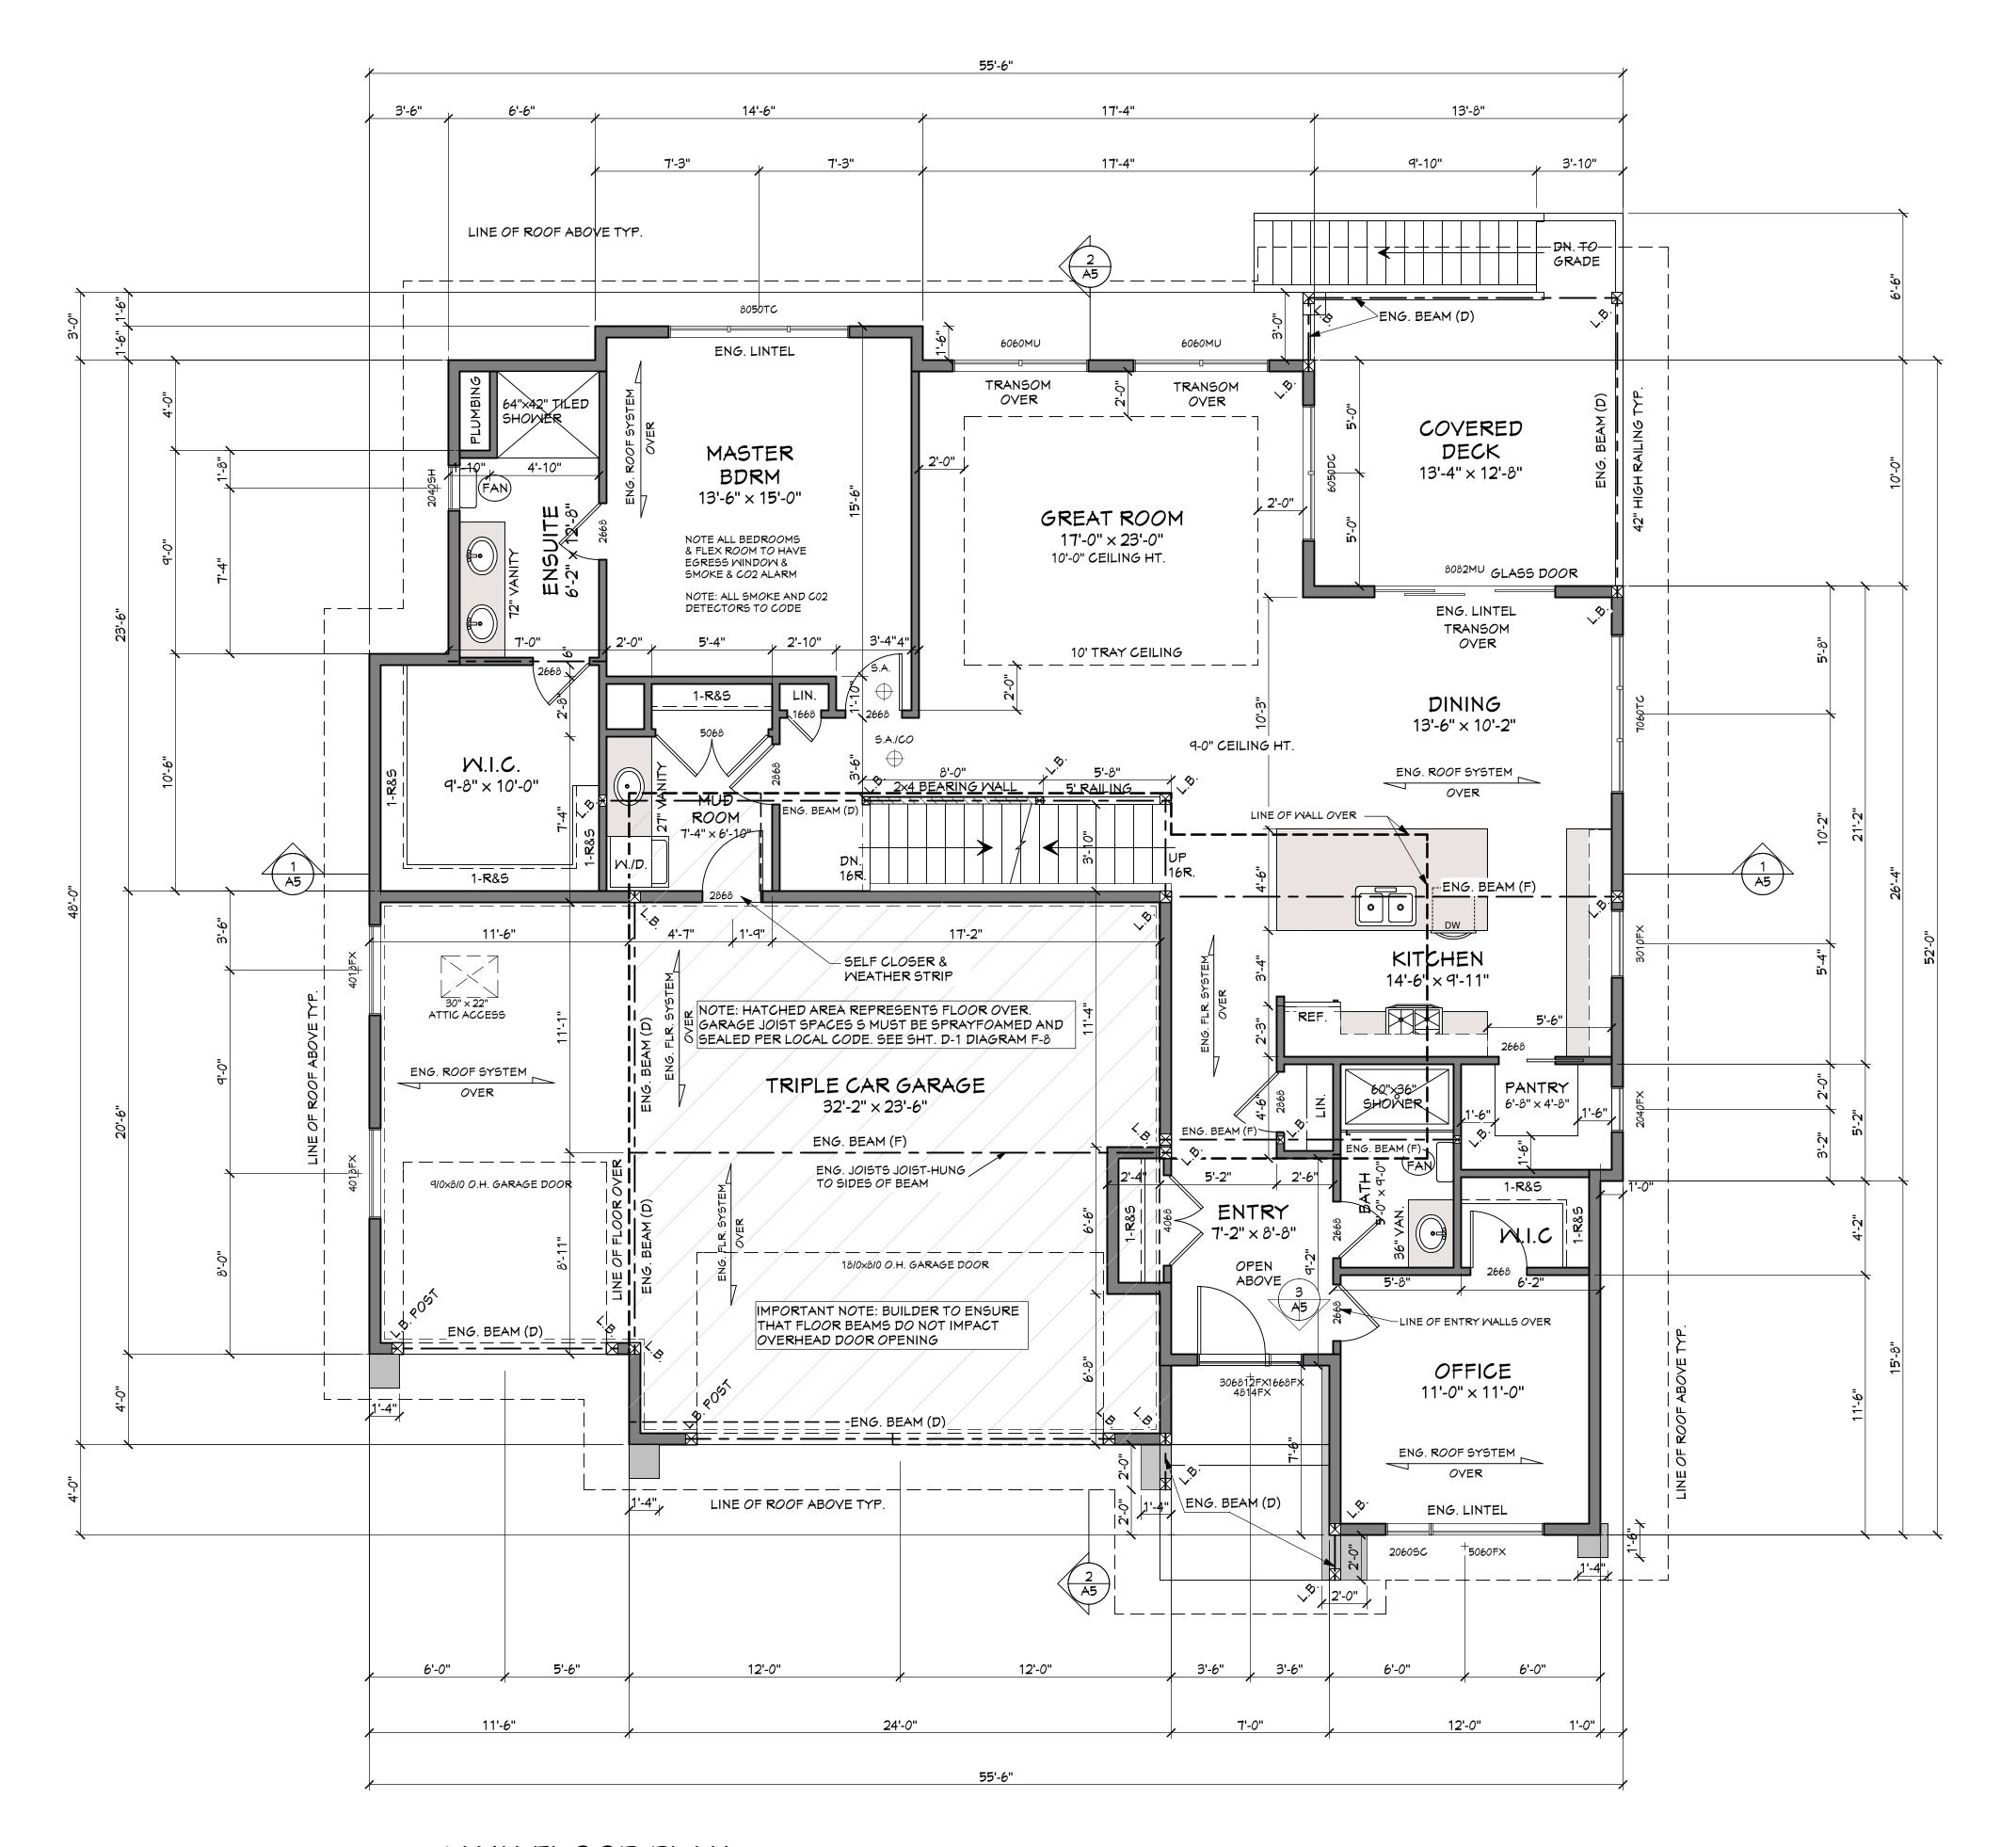
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# MAIN FLOOR PLAN

9' CEILING HEIGHT UNLESS NOTED OTHERWISE FINISHED FLOOR AREA = 1688 SQ.FT. GARAGE AREA = 781 SQ.FT. NOTE: ALL TOP OF WINDOW ROUGH OPENINGS TO BE 96" ABOYE FLOOR SURFACE.

# **GENERAL CONSTRUCTION NOTES**

#### **BEAM AND STRUCTURAL DESIGN NOTES:**

- (F) NOTE ON BEAMS DESIGNATES FLUSH, MEANING EITHER THE TOP OR BOTTOM OF THE BEAM TO NOT PROTRUDE PAST FINISHED PLANE.
- (D) NOTE ON BEAMS INDICATES A DROPPED, MEANING THE BEAM IS PLACED UNDER THE SUPPORTED STRUCTURE.
- (SEMI-F) NOTE ON BEAMS INDICATES A PARTIALLY DROPPED BEAM TO ALLOW FOR IMPACTED OPENINGS, OR TO ALLOW HEATING DUCTS TO PASS OVER. SEE DETAIL.

#### STRUCTURAL POST NOTES:

(LB) "LOAD BEARING POST" AT BEAM ENDS OR OTHER LOAD BEARING POINTS. REQUIRES STUDS TO BE NAILED TOGETHER TO FORM A STRUCTURAL POST (4X4,6X6,4X6).

#### **INTERIOR BEARING WALLS:**

UNDER ENG. FLOOR SYSTEMS: ALL OPENINGS IN INTERIOR BEARING WALLS ARE TO BE CONSTRUCTED WITH STRUCTURAL LINTELS PER FLOOR SUPPLIERS SPECIFICATIONS.

UNDER DIMENSIONAL LUMBER FLOORS: SEE LOCAL CODE FOR RESIDENTIAL BEAM SPAN LOAD CALCULATIONS.

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UNDER DIMENSIONAL LUMBER FLOORS: SEE LOCAL CODE FOR RESIDENTIAL BEAM SPAN LOAD CALCULATIONS.

#### **LUMBER NOTES:**

ALL LUMBER TO BE GRADE STAMPED, LABELLED OR OTHERWISE IDENTIFIED, AS REQUIRED BY LOCAL BUILDING CODE

#### WINDOW & DOOR NOTES:

ALL WINDOW & DOOR MEASUREMENTS ARE IN FEET & INCHES. (5040 INDICATES 5'-0" x 4'-0") CHECK ALL TOP OF WINDOW ROUGH OPENING HEIGHTS PRIOR TO FRAMING.

ACTUAL DIMENSIONS OF ROUGH OPENINGS VARY DEPENDING ON SUPPLIER ALL WINDOW SIZES, TYPES, AND OPENERS TO BE CHECKED BY CONTRACTOR PRIOR TO ORDERING.

TAKE CARE TO CHECK LOCAL BUILDING CODE FOR GLASS REGULATIONS SUCH AS TEMPERED GLASS, EGRESS LOCATIONS AND LIMITATIONS ON THE SIZE OF UNPROTECTED OPENINGS NEXT TO NEIGHBORING BLDGS. PRIOR TO ORDERING. ALL WINDOWS TO MEET ENERGY RATING OF 17ER FOR OPERATING WINDOWS & 27ER FOR FIXED WINDOWS PER CAN/CSA-A440-2.

EXTERIOR DOORS TO BE METAL INSULATED OR SOLID CORE WOOD DOORS, W/WEATHERSTRIPPING.

#### **ENGINEERED WOOD PRODUCTS NOTES:**

#### FLOOR JOIST SYSTEM NOTES:

ENGINEERED JOISTS (TJI) FLOOR SYSTEMS ARE ASSUMED ON THESE DRAWINGS.
JOIST SPANS AND JOIST DEPTHS MAY VARY DEPENDING ON THE MANUFACTURER.
IF DIMENSIONAL LUMBER JOISTS ARE USED, CALCULATIONS MUST MEET LOCAL
CODES FOR LOAD BEARING, SIZE AND SPACING.

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# ROOF DESIGN & CONSTRUCTION NOTES:

NOTES TO ROOF MANUFACTURERS

- ROOF DESIGNER TO CONSIDER DIMENSIONAL LUMBER FOR BEAMS NOTED "ENG. BEAM" AND SUBSTITUTE WHERE STRUCTURALLY POSSIBLE BY CODE.
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NOTES ON DESIGN ELEMENTS EXCEEDING CODE REQUIREMENTS:

NOTED \*\* MAY OR MAY NOT BE REQUIRED BY LOCAL CODE, BUT ARE

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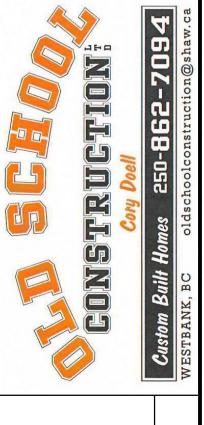
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Project # A1611 - Lot 39 Phase 11 Tally

Lot 39 Tallus Ridge Ph. 11

Client: The Tran Residence

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MAIN FLOOR
PLAN

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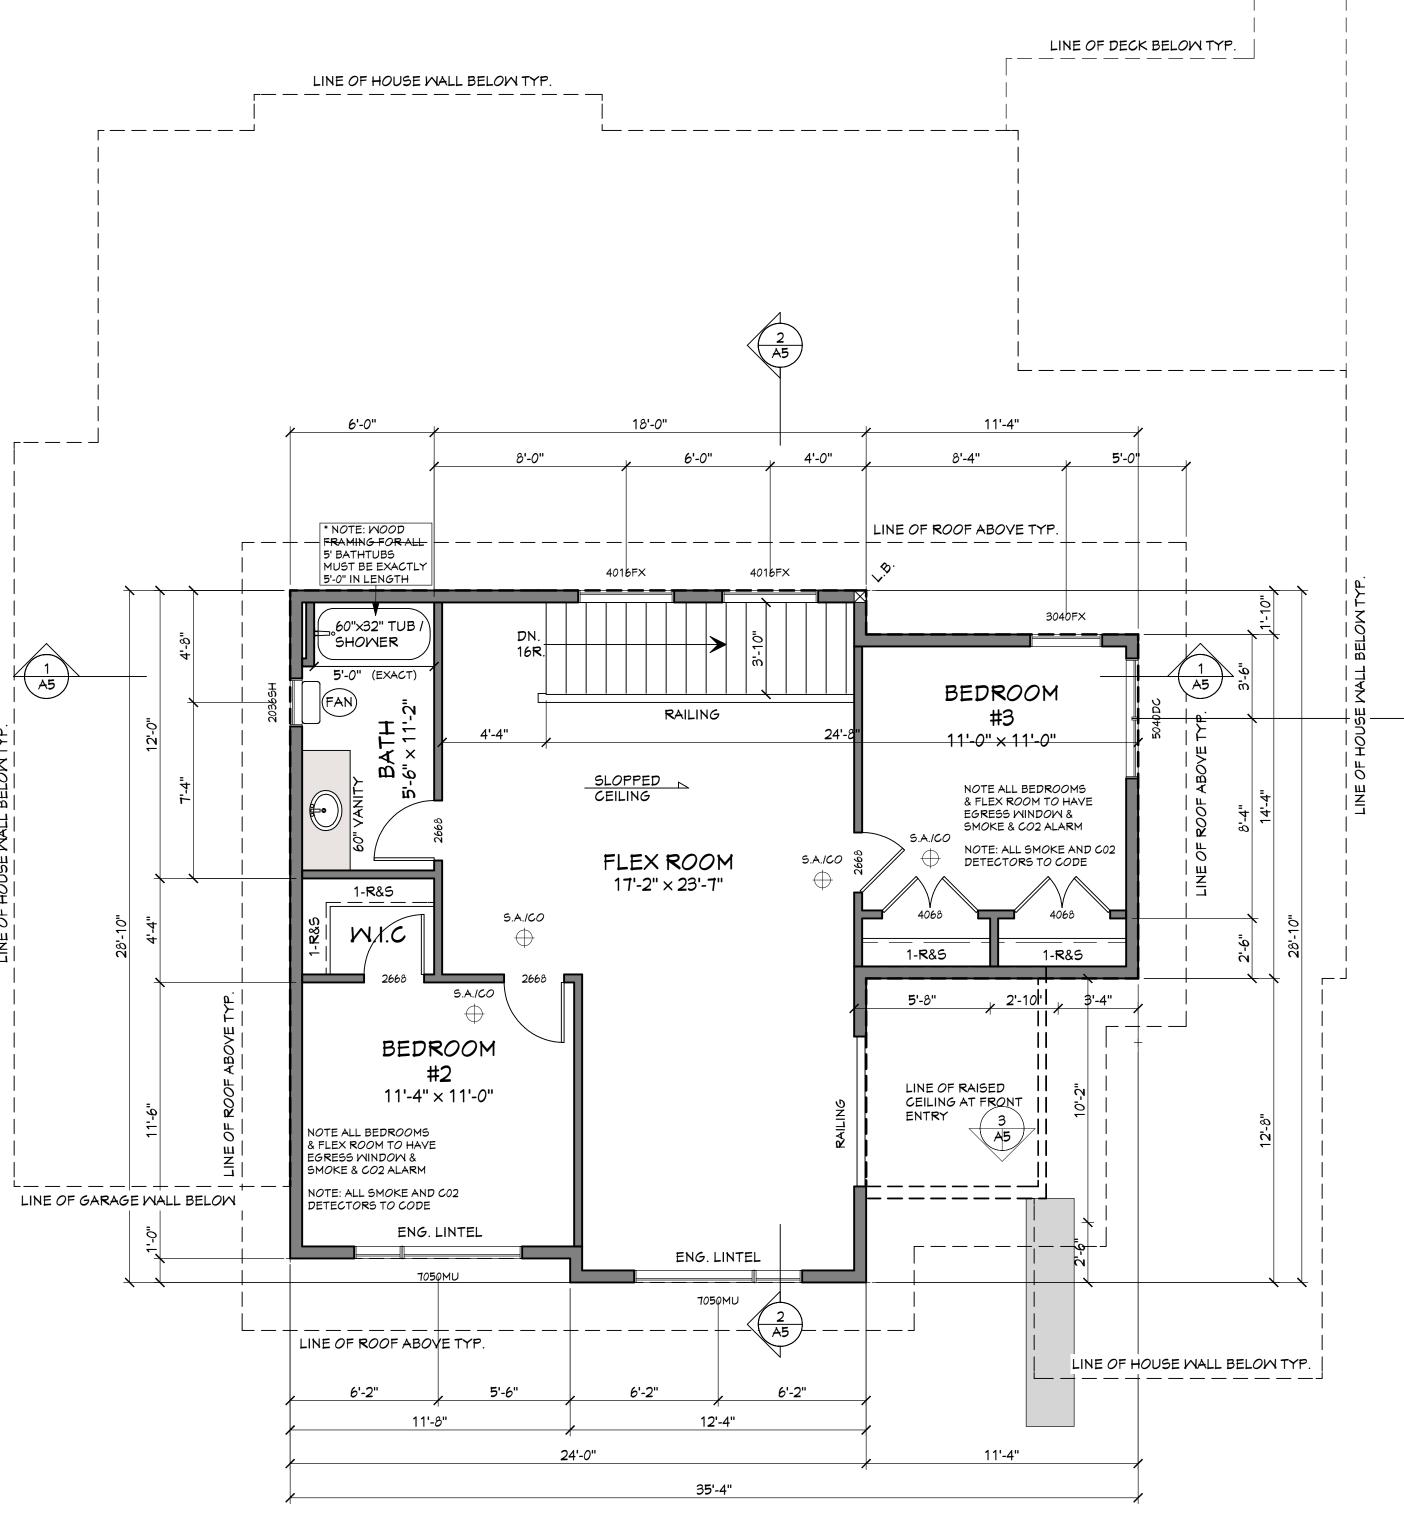
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# UPPER FLOOR PLAN

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9' CEILING HEIGHT UNLESS NOTED OTHERWISE FINISHED FLOOR AREA = 843 SQ.FT.

NOTE: ALL TOP OF WINDOW ROUGH OPENINGS TO BE 96" ABOYE FLOOR SURFACE.

# **GENERAL CONSTRUCTION NOTES:**

### **BEAM AND STRUCTURAL DESIGN NOTES:**

- NOTE ON BEAMS DESIGNATES FLUSH, MEANING EITHER THE TOP OR BOTTOM OF THE BEAM TO NOT PROTRUDE PAST FINISHED PLANE.
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### **WINDOW & DOOR NOTES:**

WEATHERSTRIPPING.

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EXTERIOR DOORS TO BE METAL INSULATED OR SOLID CORE WOOD DOORS, W/

\*\* - MATERIALS OR ASSEMBLY CONSTRUCTION MATERIALS SHOWN, AND/OR NOTED \*\* MAY OR MAY NOT BE REQUIRED BY LOCAL CODE, BUT ARE CONSIDERED GOOD BUILDING PRACTICE. BUILDING CONTRACTOR IS RESPONSIBLE TO CONSULT BOTH THE LOCAL CODE REQUIREMENTS, AND THE HOME OWNER REGARDING PLACEMENT OF THESE MATERIALS OR ASSEMBLIES.

#### **ROOF DESIGN & CONSTRUCTION NOTES:**

NOTES TO ROOF MANUFACTURERS

- ROOF DESIGNER TO CONSIDER DIMENSIONAL LUMBER FOR BEAMS NOTED "ENG. BEAM" AND SUBSTITUTE WHERE STRUCTURALLY POSSIBLE BY CODE. - TRUSS HEELS IN ALL APPLICATIONS MUST HAVE A MINIMUM 8" HEEL FOR INSULATION PURPOSES.

- CONTRACTOR MUST TAKE CARE THAT ALL BLOCKING, STRAPPING AND BRACING IS COMPLETED PER MANUFACTURERS SPECIFICATIONS AND DRAWINGS. - CONTRACTOR IS TO ENSURE G.I. FLASHINGS ARE PLACED IN ALL ROOF VALLEYS FOR PROPER RUNOFF.

- CONTRACTOR IS TO ENSURE THAT G.I. STEP FLASHINGS ARE PLACED WHEREVER WALLS AND CHIMNEYS MEET ROOF SURFACES, AND THAT STEP FLASHINGS ARE PLACED FOR PROPER RUNOFF.

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The Tran Residence

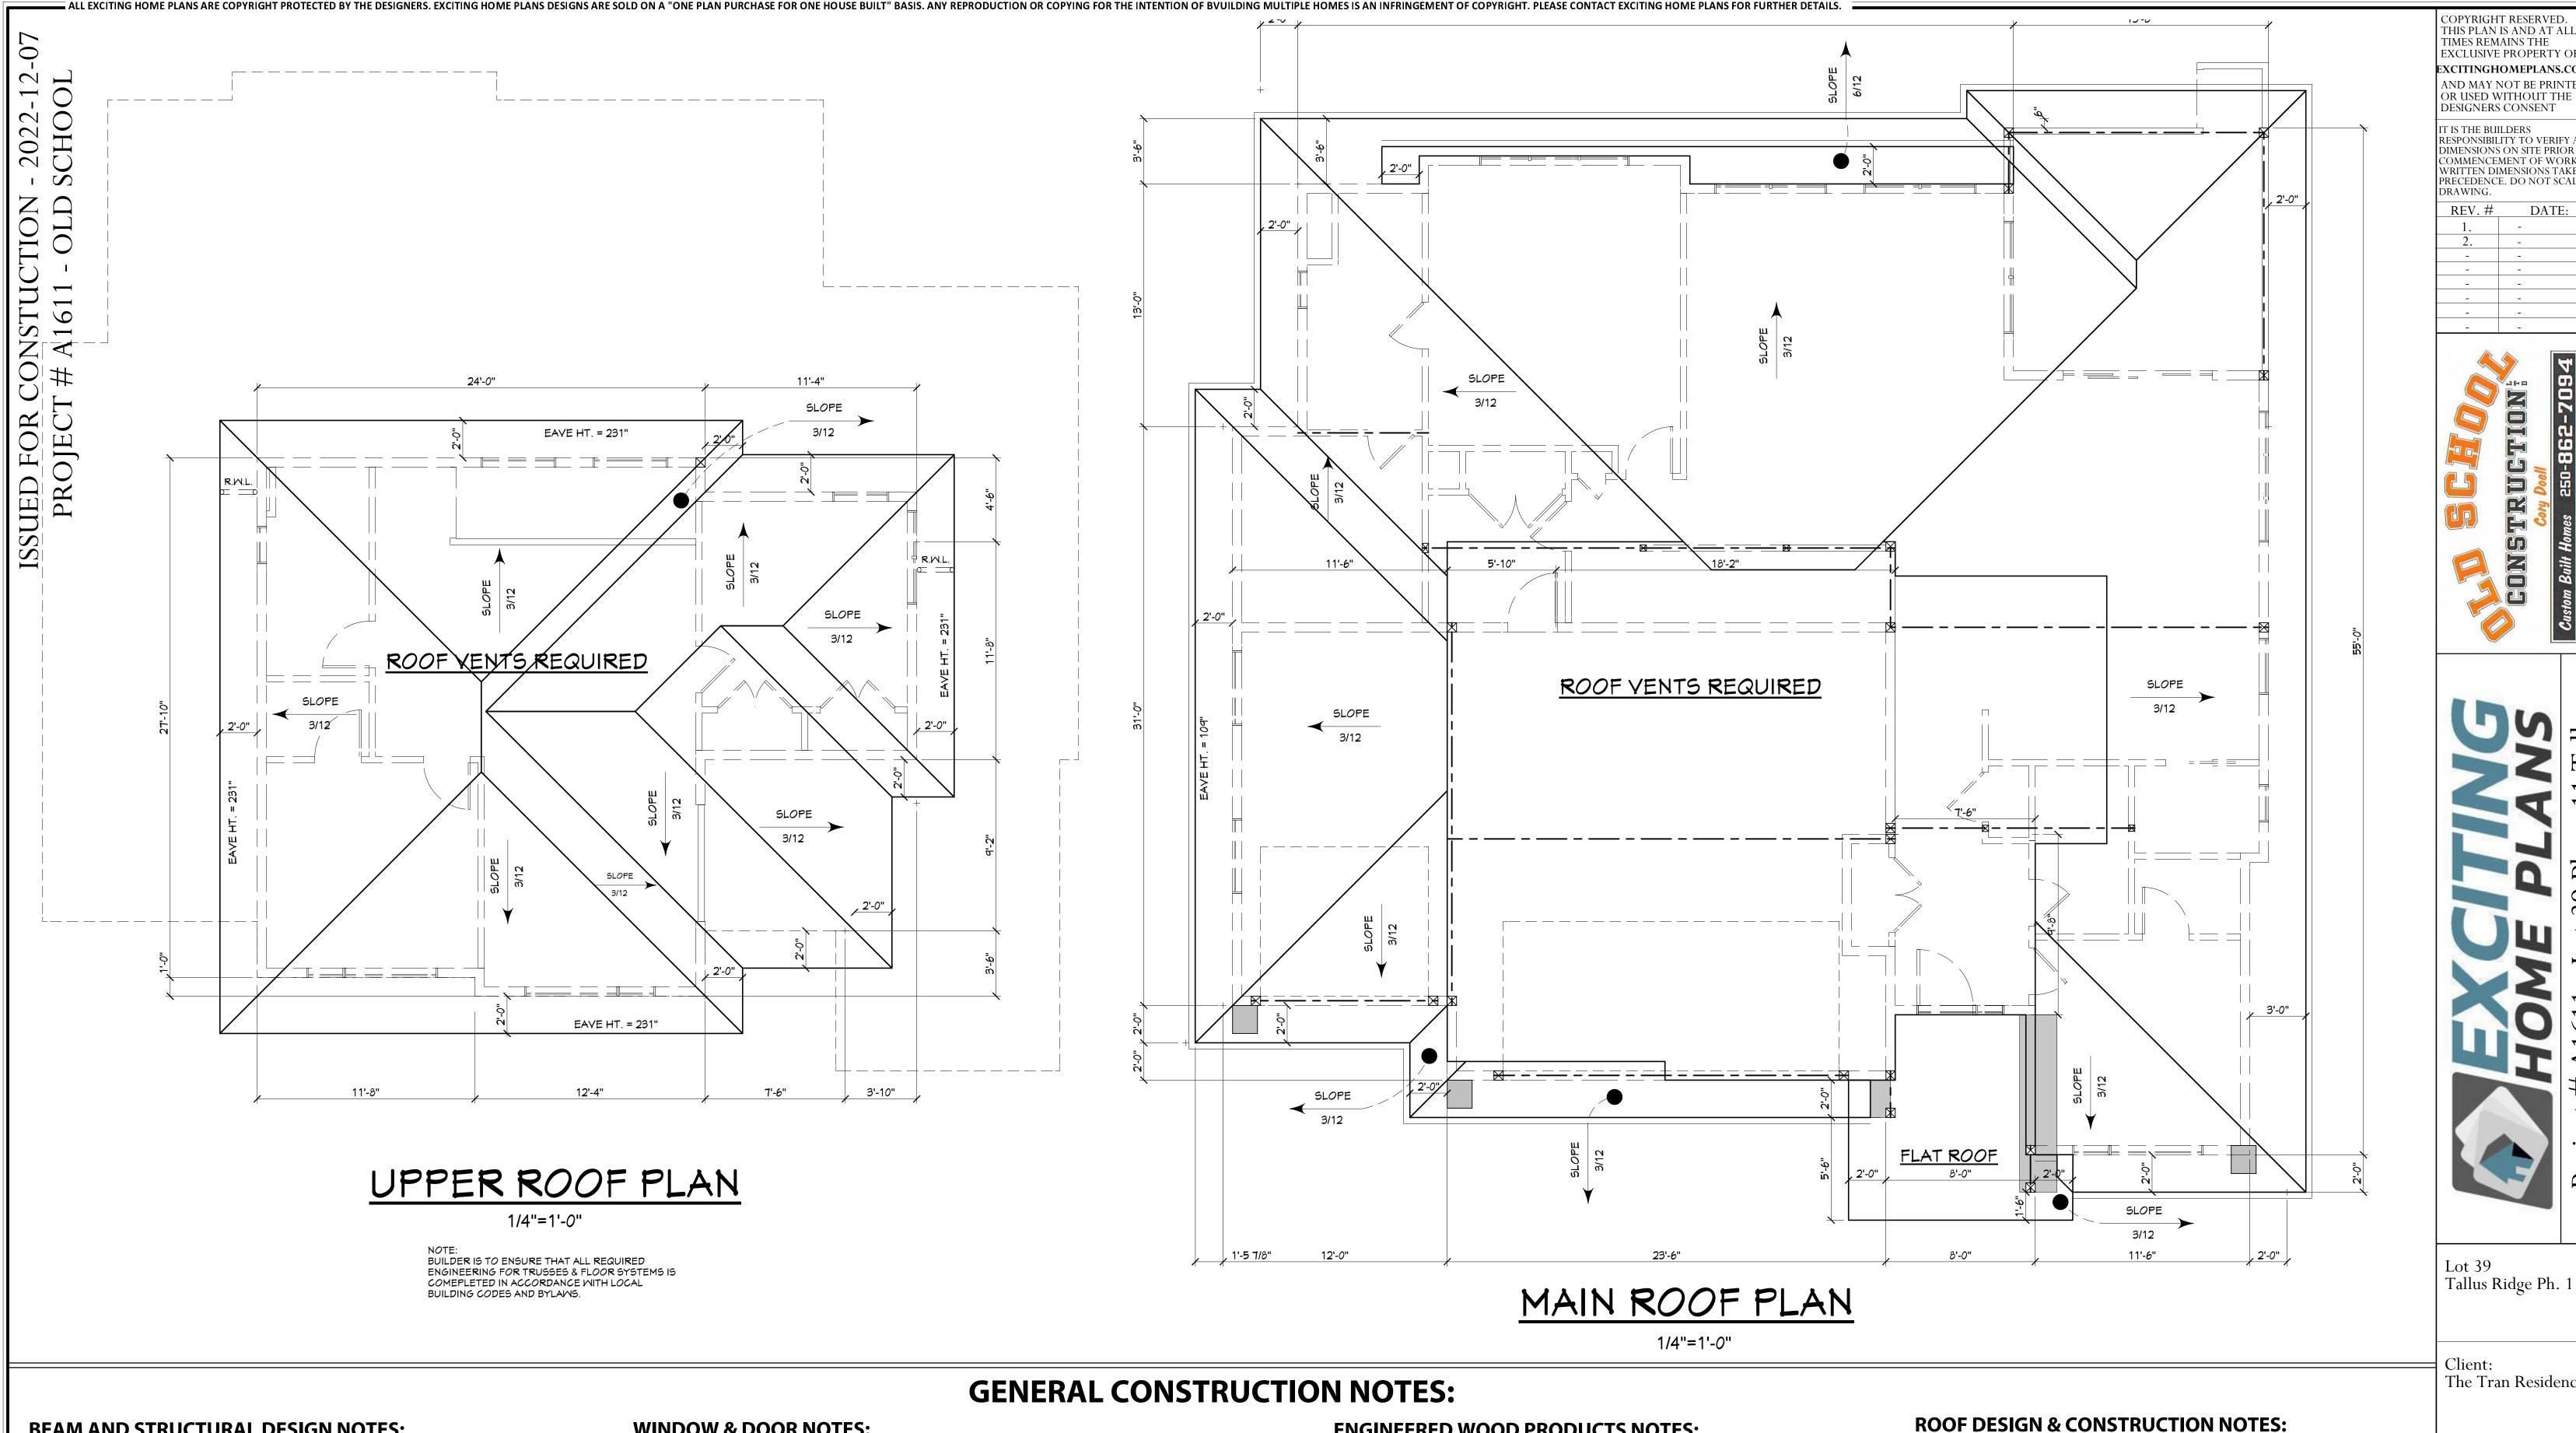
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UPPER FLOOR PLAN

PAGE:

DATE 2022-12-07 JOB# SCALE 1/4'' = 1'-0'DRAWN BY GES

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# **BEAM AND STRUCTURAL DESIGN NOTES:**

- NOTE ON BEAMS DESIGNATES FLUSH, MEANING EITHER THE TOP OR BOTTOM OF THE BEAM TO NOT PROTRUDE PAST FINISHED PLANE.
- NOTE ON BEAMS INDICATES A DROPPED, MEANING THE BEAM IS PLACED UNDER THE SUPPORTED STRUCTURE.
- (SEMI-F) NOTE ON BEAMS INDICATES A PARTIALLY DROPPED BEAM TO ALLOW FOR IMPACTED OPENINGS, OR TO ALLOW HEATING DUCTS TO PASS OVER. SEE DETAIL.

#### **LUMBER NOTES:**

ALL LUMBER TO BE GRADE STAMPED, LABELLED OR OTHERWISE IDENTIFIED, AS REQUIRED BY LOCAL BUILDING CODE

#### **STRUCTURAL POST NOTES:**

"LOAD BEARING POST" AT BEAM ENDS OR OTHER LOAD BEARING POINTS. REQUIRES STUDS TO BE NAILED TOGETHER TO FORM A STRUCTURAL POST (4X4,6X6,4X6).

#### **WINDOW & DOOR NOTES:**

ALL WINDOW & DOOR MEASUREMENTS ARE IN FEET & INCHES. (5040 INDICATES 5'-0" x 4'-0") CHECK ALL TOP OF WINDOW ROUGH OPENING HEIGHTS PRIOR TO FRAMING. ACTUAL DIMENSIONS OF ROUGH OPENINGS VARY DEPENDING ON MANUFACTURER. ALL WINDOW SIZES, TYPES, AND OPENERS TO BE CHECKED BY CONTRACTOR PRIOR TO ORDERING. TAKE CARE TO CHECK LOCAL BUILDING CODE FOR GLASS REGULATIONS SUCH AS TEMPERED GLASS, EGRESS LOCATIONS AND LIMITATIONS ON THE SIZE OF UNPROTECTED OPENINGS NEXT TO NEIGHBORING BUILDINGS PRIOR TO ORDERING. ALL WINDOWS TO MEET ENERGY RATING OF 17ER FOR OPERATING WINDOWS & 27ER FOR FIXED

WINDOWS PER CAN/CSA-A440-2. EXTERIOR DOORS TO BE METAL INSULATED OR SOLID CORE WOOD DOORS, W/ WEATHERSTRIPPING.

### **ENGINEERED WOOD PRODUCTS NOTES:**

ENGINEERED WOOD SUPPLIER/TRUSS MFR. TO PROVIDE ENGINEERED DRAWINGS, SEALED BY A P.ENG. LICENSED TO PRACTICE IN THIS HOMEPLAN'S BUILDING LOCATION, FOR THE BUILDING INSPECTOR TO REVIEW ON SITE.

#### **FLOOR JOIST SYSTEM NOTES:**

ENGINEERED JOISTS (TJI) FLOOR SYSTEMS ARE ASSUMED ON THESE DRAWINGS. JOIST SPANS AND JOIST DEPTHS MAY VARY DEPENDING ON THE MANUFACTURER. IF DIMENSIONAL LUMBER JOISTS ARE USED, CALCULATIONS MUST MEET LOCAL CODES FOR LOAD BEARING, SIZE AND SPACING.

CONTRACTOR MUST TAKE CARE THAT ALL BLOCKING, STRAPPING AND BRACING IS COMPLETED PER MANUFACTURERS SPECIFICATIONS AND DRAWINGS.

### NOTES ON DESIGN ELEMENTS EXCEEDING CODE REQUIREMENTS:

\*\* - MATERIALS OR ASSEMBLY CONSTRUCTION MATERIALS SHOWN, AND/OR NOTED \*\* MAY OR MAY NOT BE REQUIRED BY LOCAL CODE, BUT ARE CONSIDERED GOOD BUILDING PRACTICE. BUILDING CONTRACTOR IS RESPONSIBLE TO CONSULT BOTH THE LOCAL CODE REQUIREMENTS, AND THE HOME OWNER REGARDING PLACEMENT OF THESE MATERIALS OR ASSEMBLIES.

NOTES TO ROOF MANUFACTURERS

- ROOF DESIGNER TO CONSIDER DIMENSIONAL LUMBER FOR BEAMS NOTED "ENG. BEAM" AND SUBSTITUTE WHERE STRUCTURALLY POSSIBLE BY CODE. - TRUSS HEELS IN ALL APPLICATIONS MUST HAVE A MINIMUM 8" HEEL FOR INSULATION PURPOSES.

- CONTRACTOR MUST TAKE CARE THAT ALL BLOCKING, STRAPPING AND BRACING IS COMPLETED PER MANUFACTURERS SPECIFICATIONS AND DRAWINGS. - CONTRACTOR IS TO ENSURE G.I. FLASHINGS ARE PLACED IN ALL ROOF VALLEYS FOR PROPER RUNOFF.

- CONTRACTOR IS TO ENSURE THAT G.I. STEP FLASHINGS ARE PLACED WHEREVER WALLS AND CHIMNEYS MEET ROOF SURFACES, AND THAT STEP FLASHINGS ARE PLACED FOR PROPER RUNOFF.

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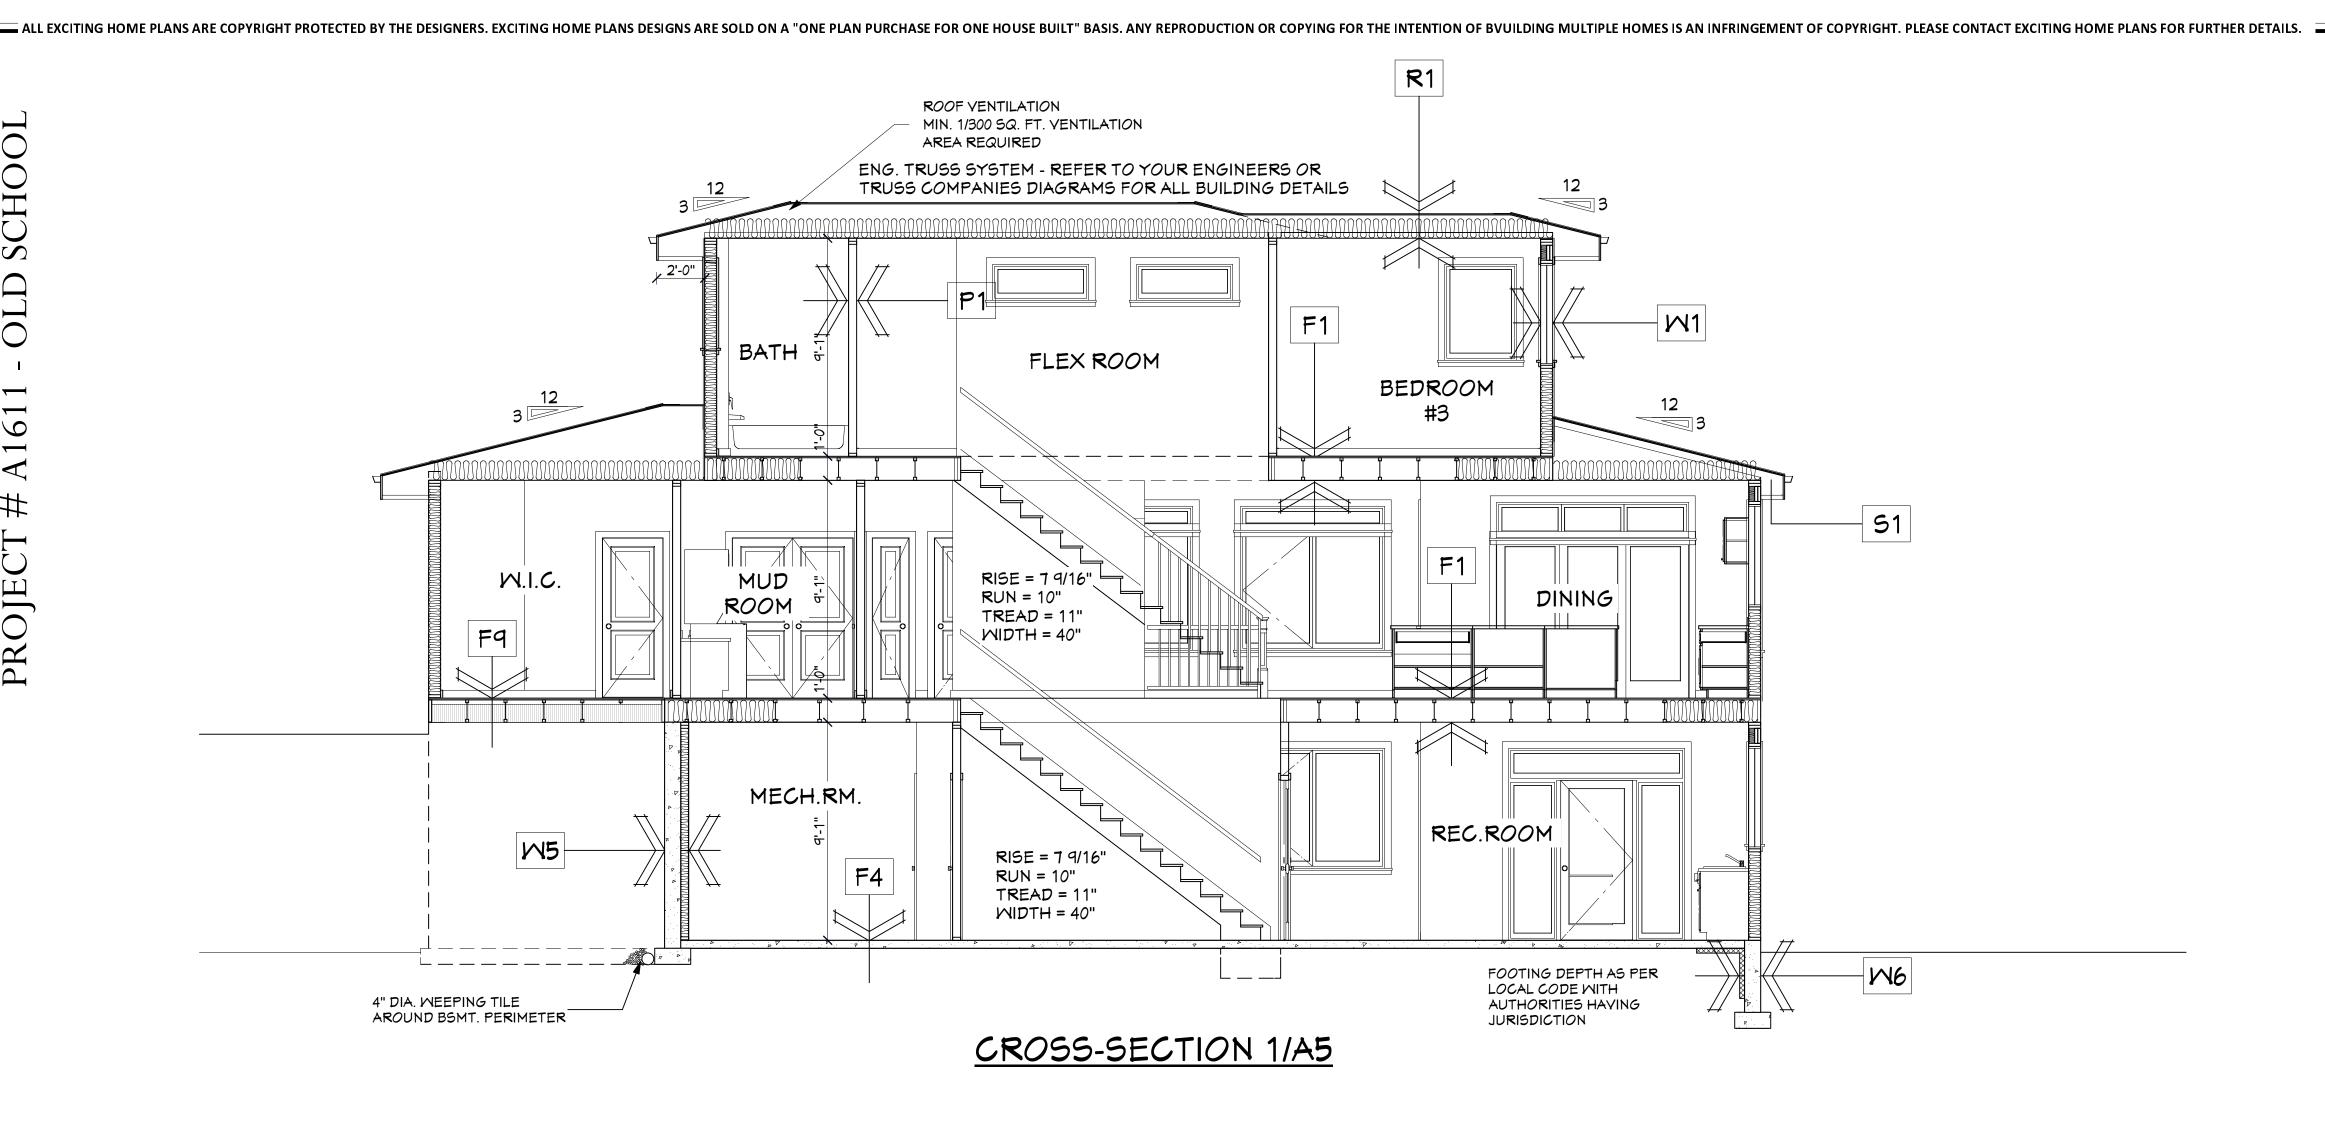
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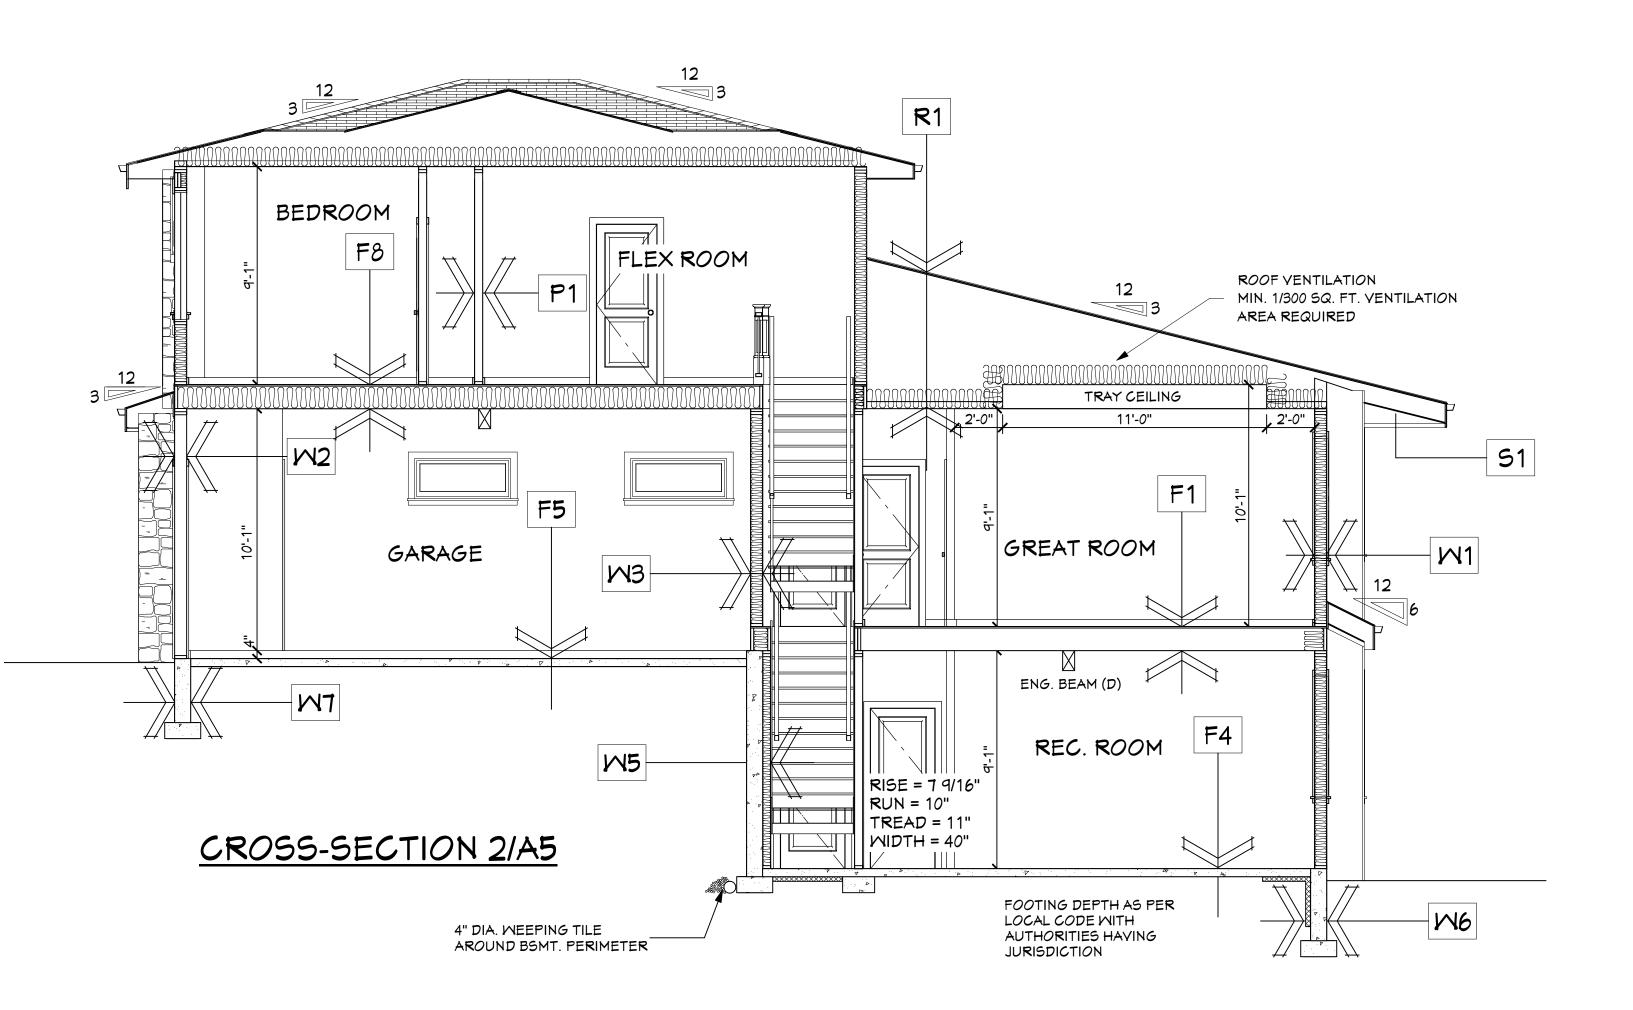
**ROOF PLAN** 

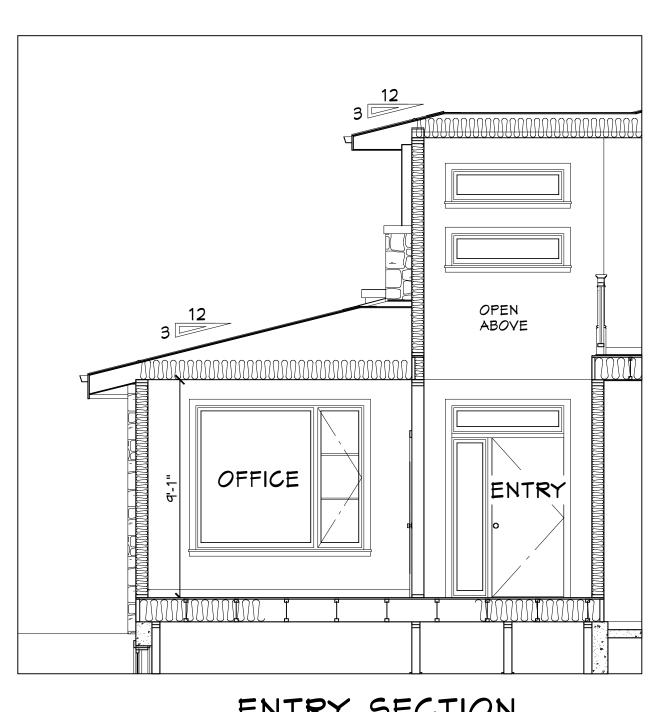
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ENTRY SECTION

CROSS-SECTION 3/A5

#### **CONSTRUCTION ASSEMBLIES:**

IMPORTANT BUILDING INSULATION AND AIRTIGHTNESS NOTES:
THE BUILDING CONTRACTOR IS RESPONSIBLE FOR ALL
CONSTRUCTION ASSEMBLIES MEETING THE LOCAL CODE RELATING
TO INSULATION STANDARDS.

SEE SHEET D-1 FOR CANADIAN BLDG. CODE INSULATION
SPECIFICATION OPTIONS FOR EXTERIOR WALL, FLOOR, ROOF AND
FOUNDATION CONSTRUCTION ASSEMBLY DETAILS WHICH
SUPERSEDE THE NOMINAL INSULATION VALUES AND ASSEMBLIES
NOTED ON THIS PAGE.

#### EXTERIOR WALL CONSTRUCTION

W1 EXTERIOR HOUSE WALLS

- SEE BUILDING ASSEMBLIES - SHEET D-1 FOR:

- VARIOUS EXTERIOR FINISH ASSEMBLY DETAILS

- INSULATION VALUES OF EACH ASSEMBLY MEETING 2018 BRITISH COLUMBIA BUILDING CODE RSI & R VALUES

W2 EXTERIOR GARAGE WALLS

STUCCO/BLDG. PAPER
- 3/8" O.S.B. SHEATHING
- 2x4 or 2x6 STUDS @ 24" O.C.
- 1/2" GYPSUM BOARD (PAINTED)
(INSULATION OPTIONAL OR AS REQUIRED BY CODE)

W3 HOUSE/GARAGE EXTERIOR WALLS

- SEE BUILDING ASSEMBLIES - SHEET D-1 FOR:

- VARIOUS EXTERIOR FINISH ASSEMBLY DETAILS

- INSULATION VALUES OF EACH ASSEMBLY MEETING 2018 BRITISH COLUMBIA BUILDING CODE RSI & R VALUES

W4 FOUNDATION WALLS - UNFINISHED AREAS

- SEE BUILDING ASSEMBLIES - SHEET D-1 FOR:

- VARIOUS EXTERIOR FINISH ASSEMBLY DETAILS

- INSULATION VALUES OF EACH ASSEMBLY
MEETING 2018 BRITISH COLUMBIA BUILDING
CODE RSI & R VALUES

W5 FOUNDATION WALLS - FINISHED AREAS

- SEE BUILDING ASSEMBLIES - SHEET D-1 FOR:

- VARIOUS EXTERIOR FINISH ASSEMBLY DETAILS

- INSULATION VALUES OF EACH ASSEMBLY MEETING 2018 BRITISH COLUMBIA BUILDING CODE RSI & R VALUES

W6 FOUNDATION WALLS - FROST WALLS

- SEE BUILDING ASSEMBLIES - SHEET D-1 FOR:

- VARIOUS EXTERIOR FINISH ASSEMBLY DETAILS

- INSULATION VALUES OF EACH ASSEMBLY
MEETING 2018 BRITISH COLUMBIA BUILDING
CODE RSI & R VALUES

FOUNDATION WALLS - GARAGE FROST WALLS
- 8" CONCRETE FOUNDATION WALL
ON 16"x 8" CONC. STRIP FOOTING
(FOOTING DEPTH PER LOCAL FROST
PENETRATION AND CODE REQUIREMENTS)

#### **INTERIOR PARTITION CONSTRUCTION**

P1 INTERIOR WALLS - (TYP.)
- 1/2" GYPSUM BOARD (PAINTED)
- 2x4 or 2x6 STUDS @ 16" O.C.
- 1/2" GYPSUM BOARD (PAINTED)

P2 INTERIOR WALLS - INSULATED
- 1/2" GYPSUM BOARD (PAINTED)
- 2x4 or 2x6 STUDS @ 16" O.C.
- R-12 SOUND INSULATION
- 1/2" GYPSUM BOARD (PAINTED)

F2 JOISTED DECK AND PORCH FLOORS

- VENTED ALUMINUM SOFFIT

CODE RSI & R VALUES

| F6 | CONCRETE FLOORS - PATIOS

- 3/4" T&G O.S.B. GLUED NAILED & SCREWED - ENG. JOIST SYSTEM ( MATERIAL AND

INSTALLATION PER MANUFACTURER)
- 1x4 SOFFIT STRAPPING IF NECESSARY

- 4" CONCRETE SLAB (SLOPED TO DRAIN)

FINISHED FLOOR

#### FLOOR CONSTRUCTION

F1 JOISTED HOUSE FLOOR
- FINISHED FLOOR
- 3/4" T&G O.S.B. GLUED NAILED & SCREWED
- ENG. JOIST SYSTEM ( MATERIAL AND INSTALLATION PER MANUFACTURER)
- 1/2" CEILING BOARD
- PAINTED FINISH

F3 JOISTED HOUSE FLOOR TO EXTERIOR AREA

- SEE BUILDING ASSEMBLIES - SHEET D-1 FOR:

- BUILDING ASSEMBLY DETAILS

- INSULATION VALUES OF EACH ASSEMBLY MEETING 2018 BRITISH COLUMBIA BUILDING

F4 CONCRETE FLOORS - BASEMENT

- SEE BUILDING ASSEMBLIES - SHEET D-1 FOR:

- BUILDING ASSEMBLY DETAILS

- INSULATION VALUES OF EACH ASSEMBLY MEETING 2018 BRITISH COLUMBIA BUILDING

F5 CONCRETE FLOORS - GARAGE
- 4" CONCRETE SLAB (SLOPED TO DRAIN)
- 10 mm REBAR @ 24" GRID
- 6 MIL. VAPOUR BARRIER
- 5" COMPACTED GRANULAR FILL

CODE RSI & R VALUES

- 10 mm REBAR @ 24" GRID
- 6 MIL. VAPOUR BARRIER
- 5" COMPACTED GRANULAR FILL

F7 JOISTED DECK FLOOR TO GARAGE BELOW
- FINISHED FLOOR
- 3/4" T&G O.S.B. GLUED NAILED & SCREWED
- ENG. JOIST SYSTEM (MATERIAL AND
- 10 mm REBAR @ 24" GRID
- 6 MIL. VAPOUR BARRIER
- 5" COMPACTED GRANULAR FILL

F8 HOUSE FLOOR TO GARAGE BELOW
- SEE BUILDING ASSEMBLIES - SHEET D-1 FOR:
- BUILDING ASSEMBLY DETAILS

- PAINTED FINISH

F9 JOISTED DECK FLOOR TO HEATED AREA BELOW
- SEE BUILDING ASSEMBLIES - SHEET D-1 FOR:
- BUILDING ASSEMBLY DETAILS
- INSULATION VALUES OF EACH ASSEMBLY

MEETING 2018 BRITISH COLUMBIA BUILDING

INSTALLATION PER MANUFACTURER)
- INSULATION OPTIONAL
- 5/8" TYPE "X" FIREGUARD CEILING BOARD
- PAINTED FINISH

- INSULATION VALUES OF EACH ASSEMBLY
MEETING 2018 BRITISH COLUMBIA BUILDING
CODE RSI & R VALUES

- INSULATION VALUES OF EACH ASSEMBLY
MEETING 2018 BRITISH COLUMBIA BUILDING
CODE RSI & R VALUES

#### ROOF AND CEILING CONSTRUCTION

R3 DECK AND PORCH ROOF & CEILING

CODE RSI & R VALUES

R1 HOUSE ROOF AND CEILING

- SEE BUILDING ASSEMBLIES - SHEET D-1 FOR:

- BUILDING ASSEMBLY DETAILS

- INSULATION VALUES OF EACH ASSEMBLY
MEETING 2018 BRITISH COLUMBIA BUILDING
CODE RSI & R VALUES

- LAMINATED ASPHALT SHINGLES
- ROOFING FELT
- 7/16" ROOF SHEATHING (c/w "H" CLIPS)
-ENG. ROOF TRUSSES @ 24" O.C. - MATERIALS
AND ASSEMBLY PER MANUFACTURER
- 1x4 SOFFIT STRAPPING IF NECESSARY
- VENTED ALUMINUM SOFFIT

R2 GARAGE ROOF & CEILING

- LAMINATED ASPHALT SHINGLES
- ROOFING FELT
- 7/16" ROOF SHEATHING (c/w "H" CLIPS)
-ENG. ROOF TRUSSES @ 24" O.C. - MATERIALS AND
ASSEMBLY PER MANUFACTURER
- 1/2" CEILING BOARD (TYPE "X" FIREGUARD
WHERE REQUIRED BY CODE)

#### SOFFIT SPECIFICATIONS

S1 - PREFINISHED VENTED ALUMINUM SOFFIT

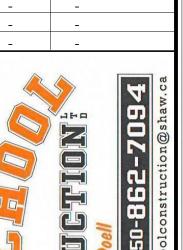
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Cory Doell

Custom Built Homes 250-862-7

Project # A1611 - Lot 39 Phase 11 Tallu

Lot 39 Tallus Ridge Ph. 11

Client: The Tran Residence

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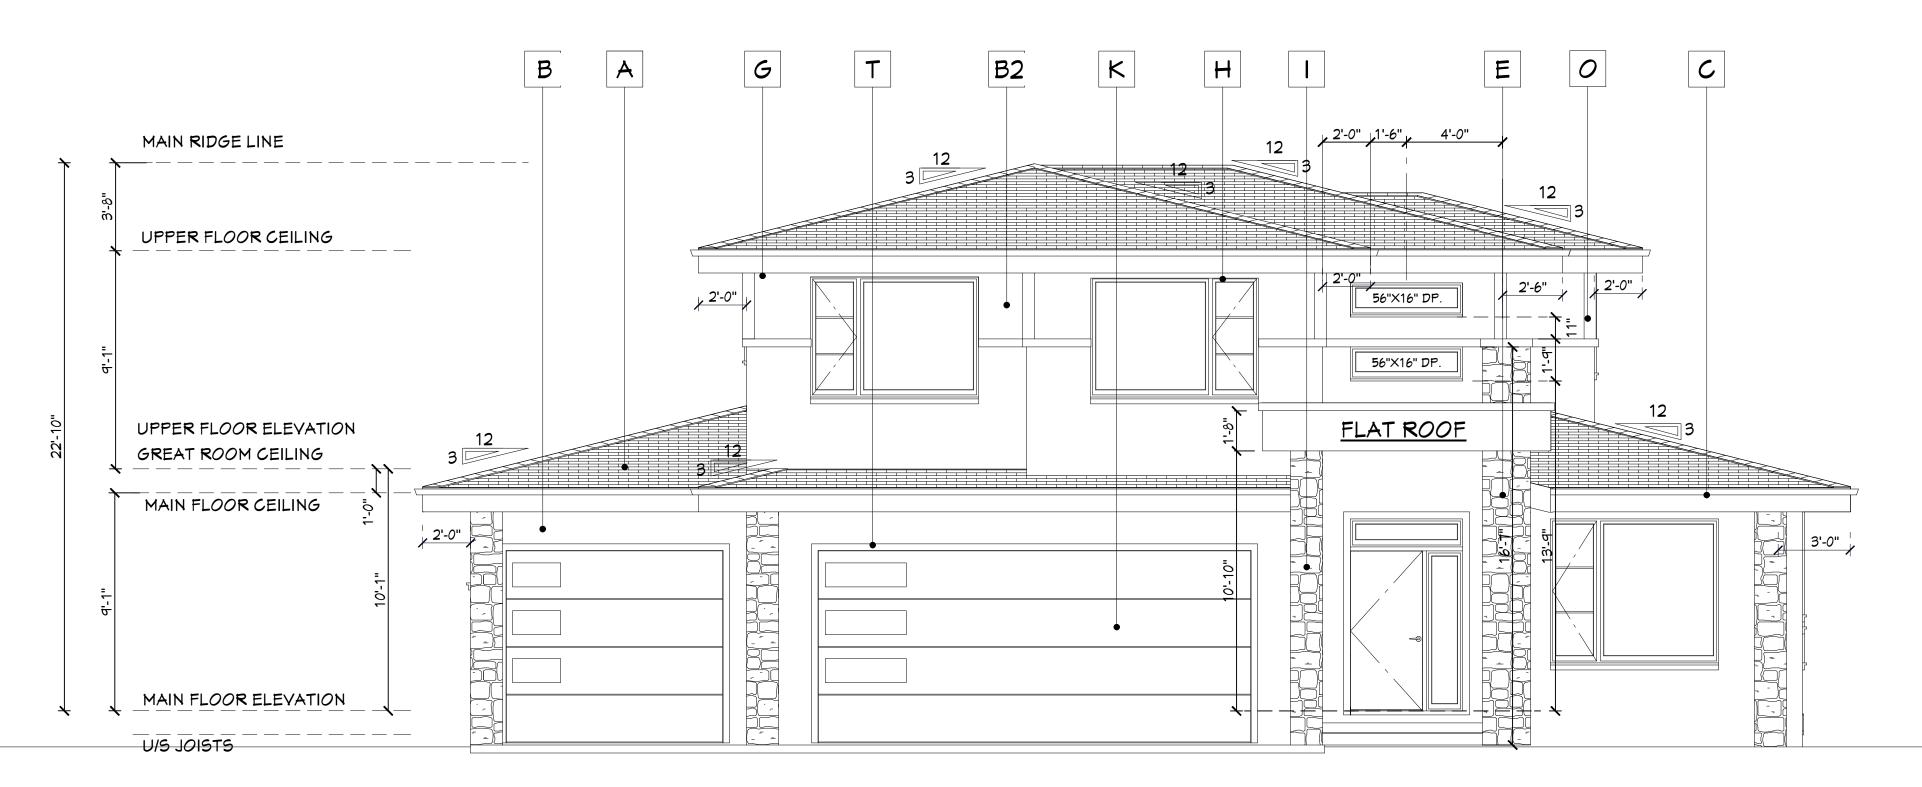
DATE 2022-12-07

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SCALE 1/4" = 1'-0'

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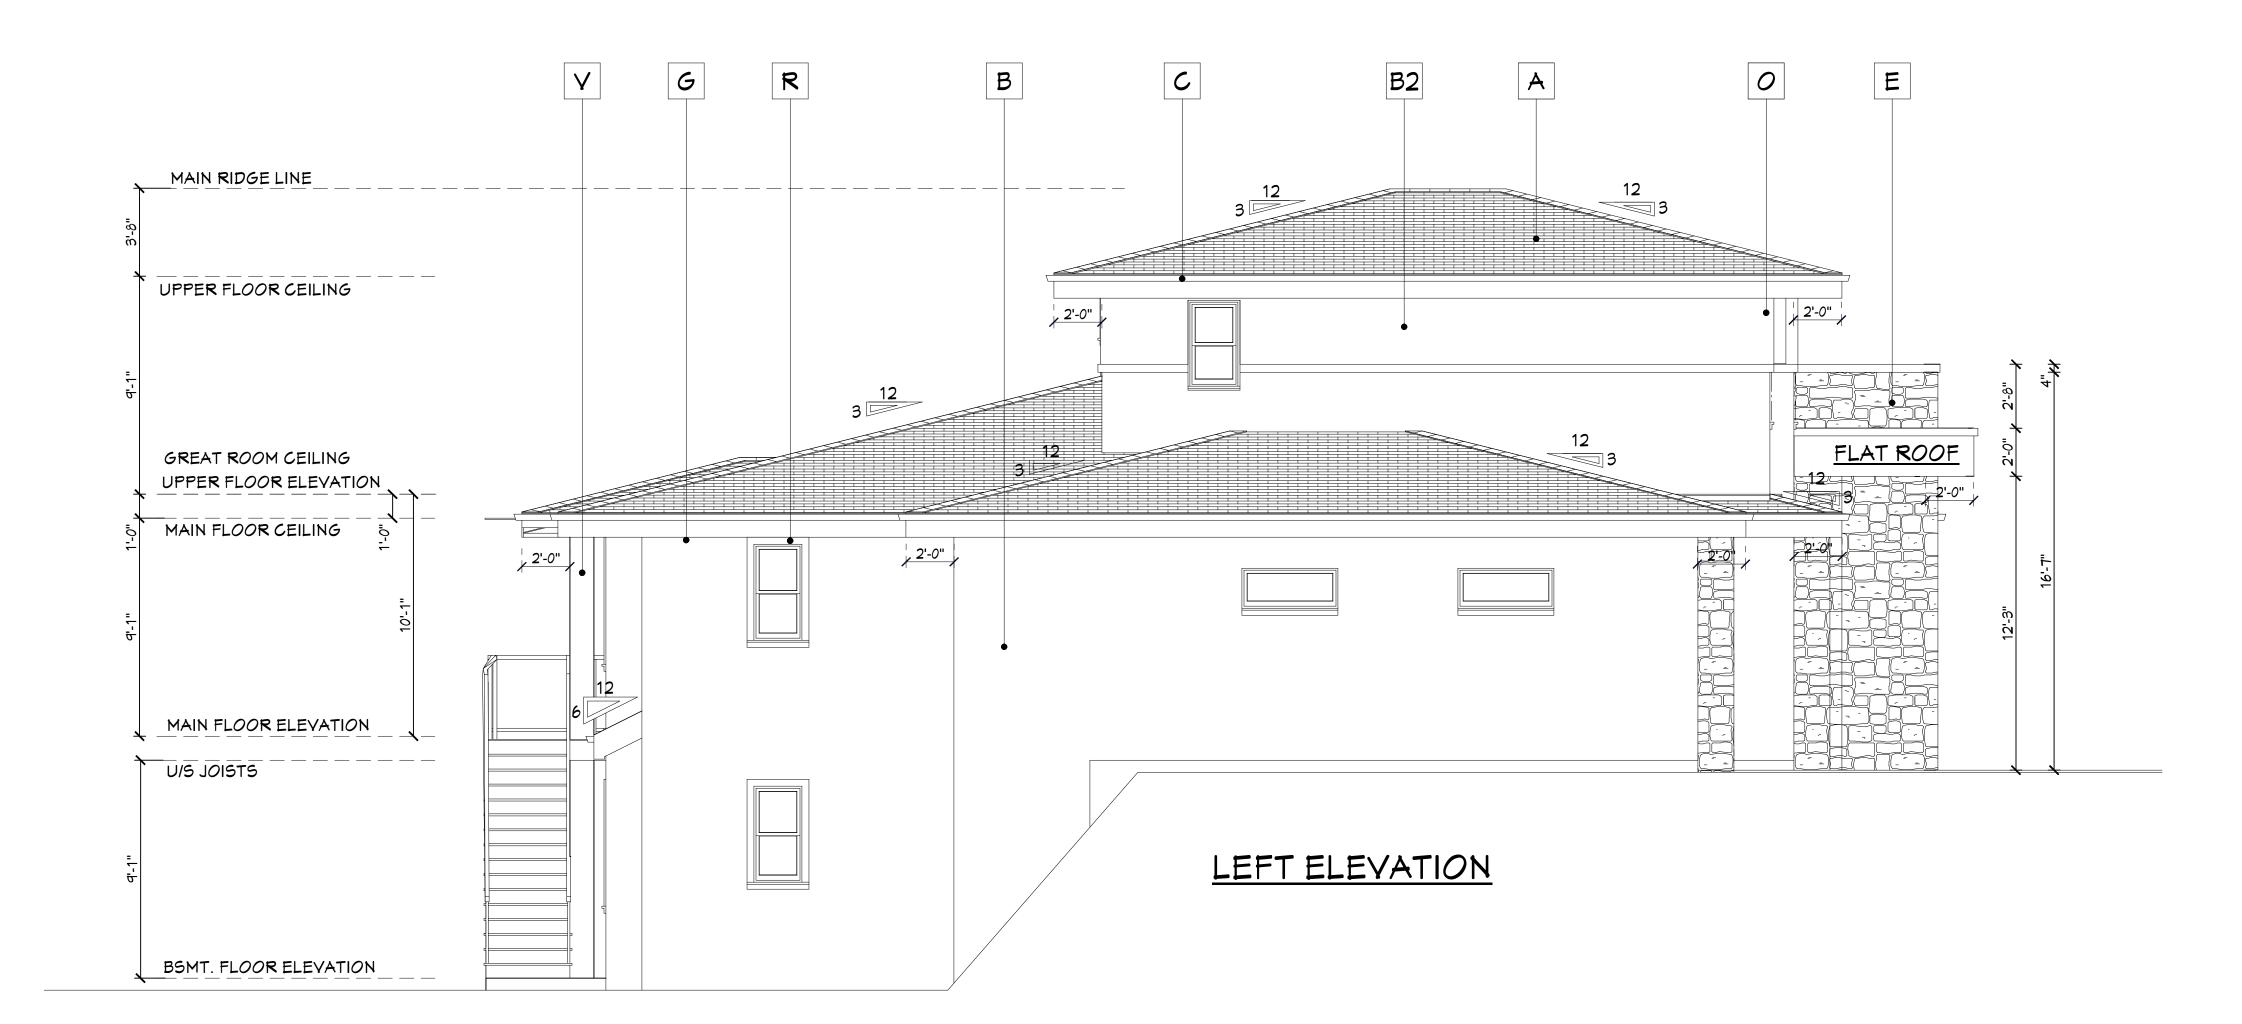
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Project # A1343 - Lot 11 Ph 9 Tallus



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MATERIAL & EXTERIOR FINISH LEGEND:

- **ROOF LAMINATED ASPHALT SHINGLES**
- B EXT. WALLS HARDIE PLANK SIDING
- B1 WOOD / BATTON
- B2 ACRYLIC STUCCO
- C 12" FASCIA w/ PRE FIN. ALUM. GUTTER & DOWNSPOUTS
- D 42" HIGH PREFIN. ALUM & GLASS DECK RAILING (AS PER LOCAL CODE **REQUIREMENTS)**
- E STONE OR BRICK VENEER
- F HARDIE-SHAKE GABLE END FINISH
- G PREFIN. ALUM. SOFFIT
- H FRONT ELEV. WINDOW & DOOR TRIM 6" HORIZ. HARDIE TRIM **3" WRAP AT SIDES** 4" VERT. HARDIE TRIM
- I FRONT ELEVATION COLUMNS **DECOR. WOOD CAPITALS** 18" SQ. FRAMED OUT COLUMN w/ WOOD BASE SURROUND ON MASONRY VENEER BASE w/ PREFINISHED SILL
- J DECORATIVE BRACKETS
- K GARAGE DOOR
- L 10" HARDIE HORIZ. GABLE BAND
- M GABLE END TIMBER FRAME
- N 4" ON 10" HARDIE GABLE FASCIA
- O 6" HARDIE WALL CORNER BOARDS
- P FRONT ELEVATION PICKET RAILING
- Q 2" x 10" HARDIE BELLY BAND
- R 4" HARDIE WINDOW & DOOR TRIMS
- S ARCHITECTURAL TOOTHING
- T GARAGE DOOR TRIM 6" HORIZ. HARDIE-BOARD 4" VERT. HARDIE-BOARD
- U PREFIN. ALUM. FACED EXTERIOR ITEMS
- V REAR COLUMNS SPECIFICATION DECORATIVE ACRYLIC STUCCO BUILTOUT CAPITALS ON 18" SQ. FRAMED OUT COLUMNS w/ MASONRY OR ACRYLIC STUCCO BASE

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Lot 39 Tallus Ridge Ph. 11

Client: The Tran Residence

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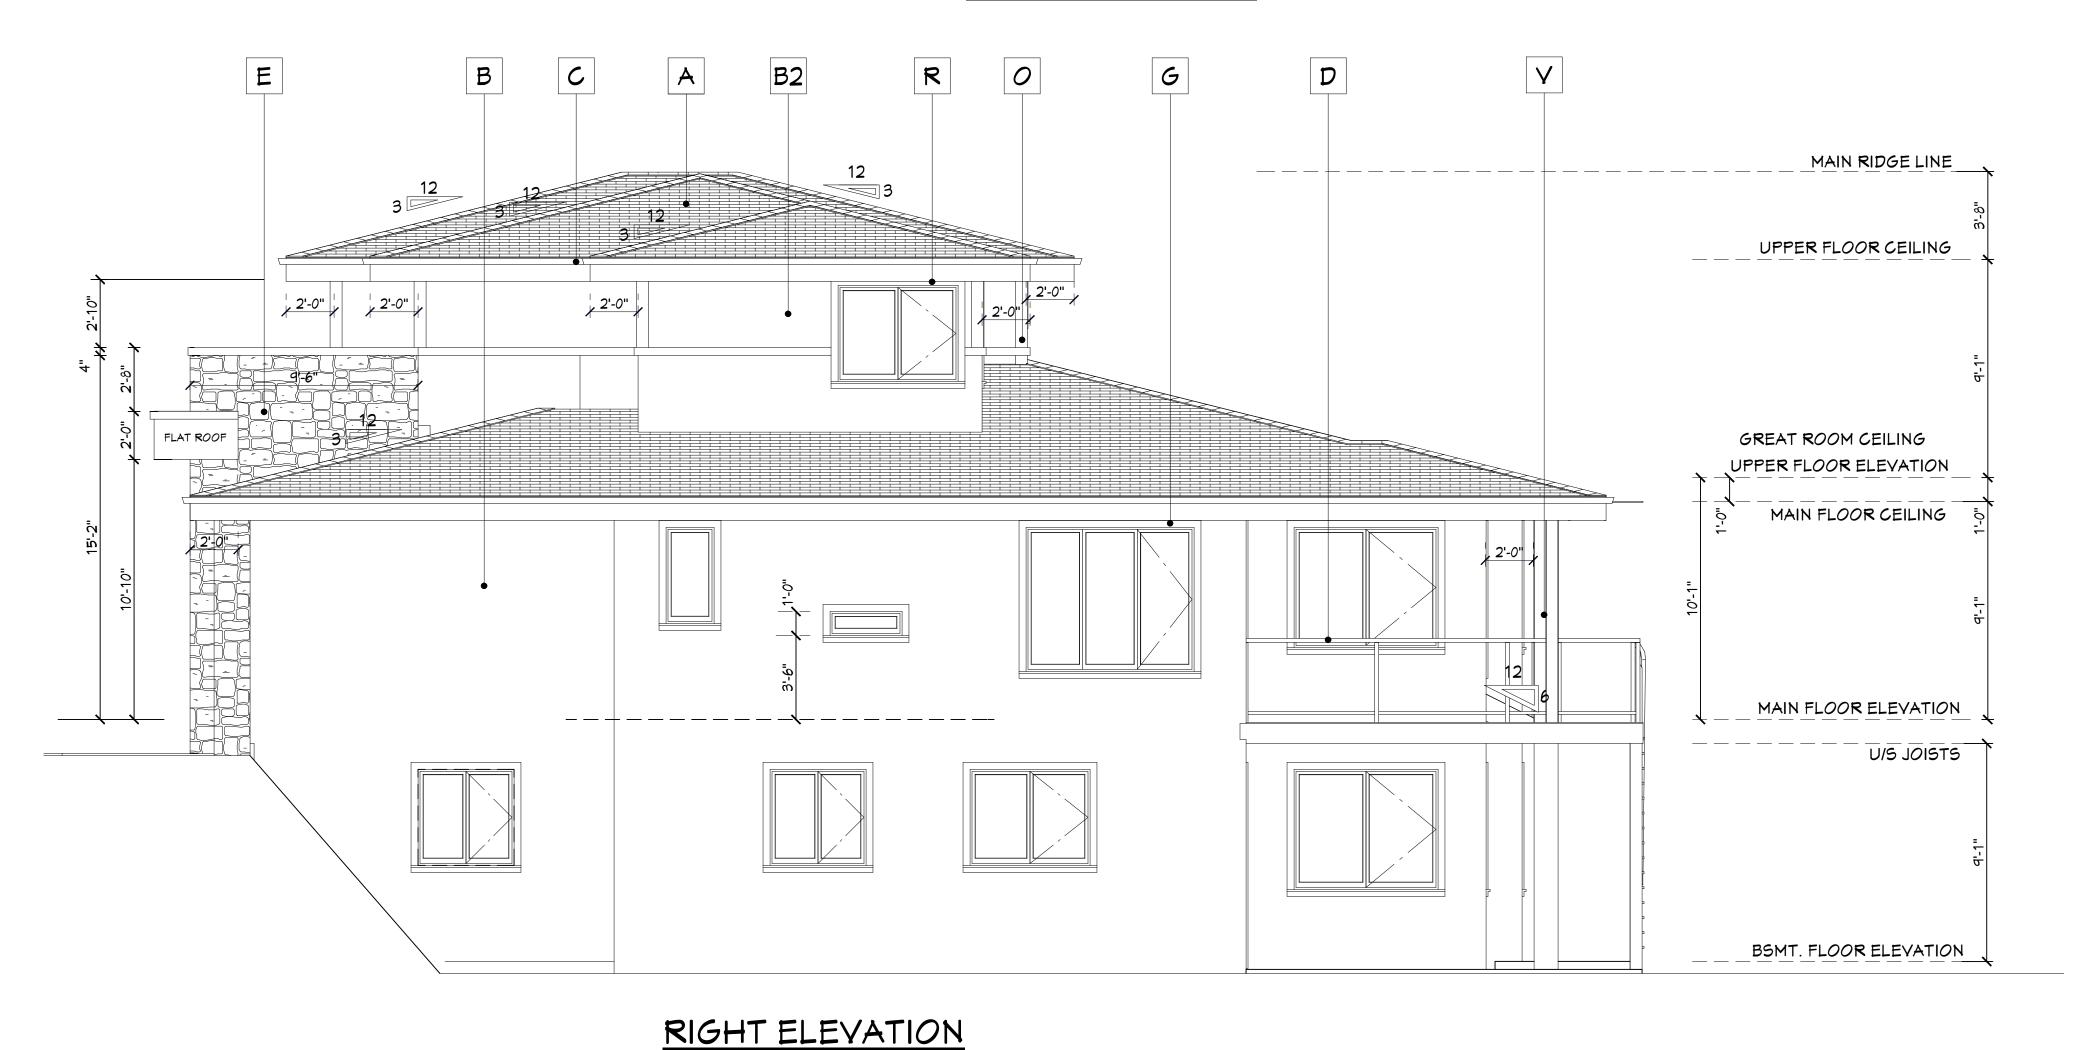
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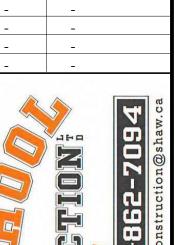
- A ROOF LAMINATED ASPHALT SHINGLES
- B EXT. WALLS HARDIE PLANK SIDING
- B1 WOOD / BATTON
- B2 ACRYLIC STUCCO
- C 12" FASCIA w/ PRE FIN. ALUM. GUTTER & DOWNSPOUTS
- D 42" HIGH PREFIN. ALUM & GLASS DECK RAILING (AS PER LOCAL CODE REQUIREMENTS)
- E STONE OR BRICK VENEER
- F HARDIE-SHAKE GABLE END FINISH
- G PREFIN. ALUM. SOFFIT
- H FRONT ELEV. WINDOW & DOOR TRIM
  6" HORIZ. HARDIE TRIM
  3" WRAP AT SIDES
  4" VERT. HARDIE TRIM
- I FRONT ELEVATION COLUMNS
  DECOR. WOOD CAPITALS
  18" SQ. FRAMED OUT COLUMN w/
  WOOD BASE SURROUND ON
  MASONRY VENEER BASE w/
  PREFINISHED SILL
- J DECORATIVE BRACKETS
- K GARAGE DOOR
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- T GARAGE DOOR TRIM 6" HORIZ. HARDIE-BOARD 4" VERT. HARDIE-BOARD
- U PREFIN. ALUM. FACED EXTERIOR ITEMS
- REAR COLUMNS SPECIFICATION
  DECORATIVE ACRYLIC STUCCO
  BUILTOUT CAPITALS ON
  18" SQ. FRAMED OUT COLUMNS w/
  MASONRY OR ACRYLIC STUCCO BASE

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Lot 39 Tallus Ridge Ph. 11

Client: The Tran Residence

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EXTERIOR

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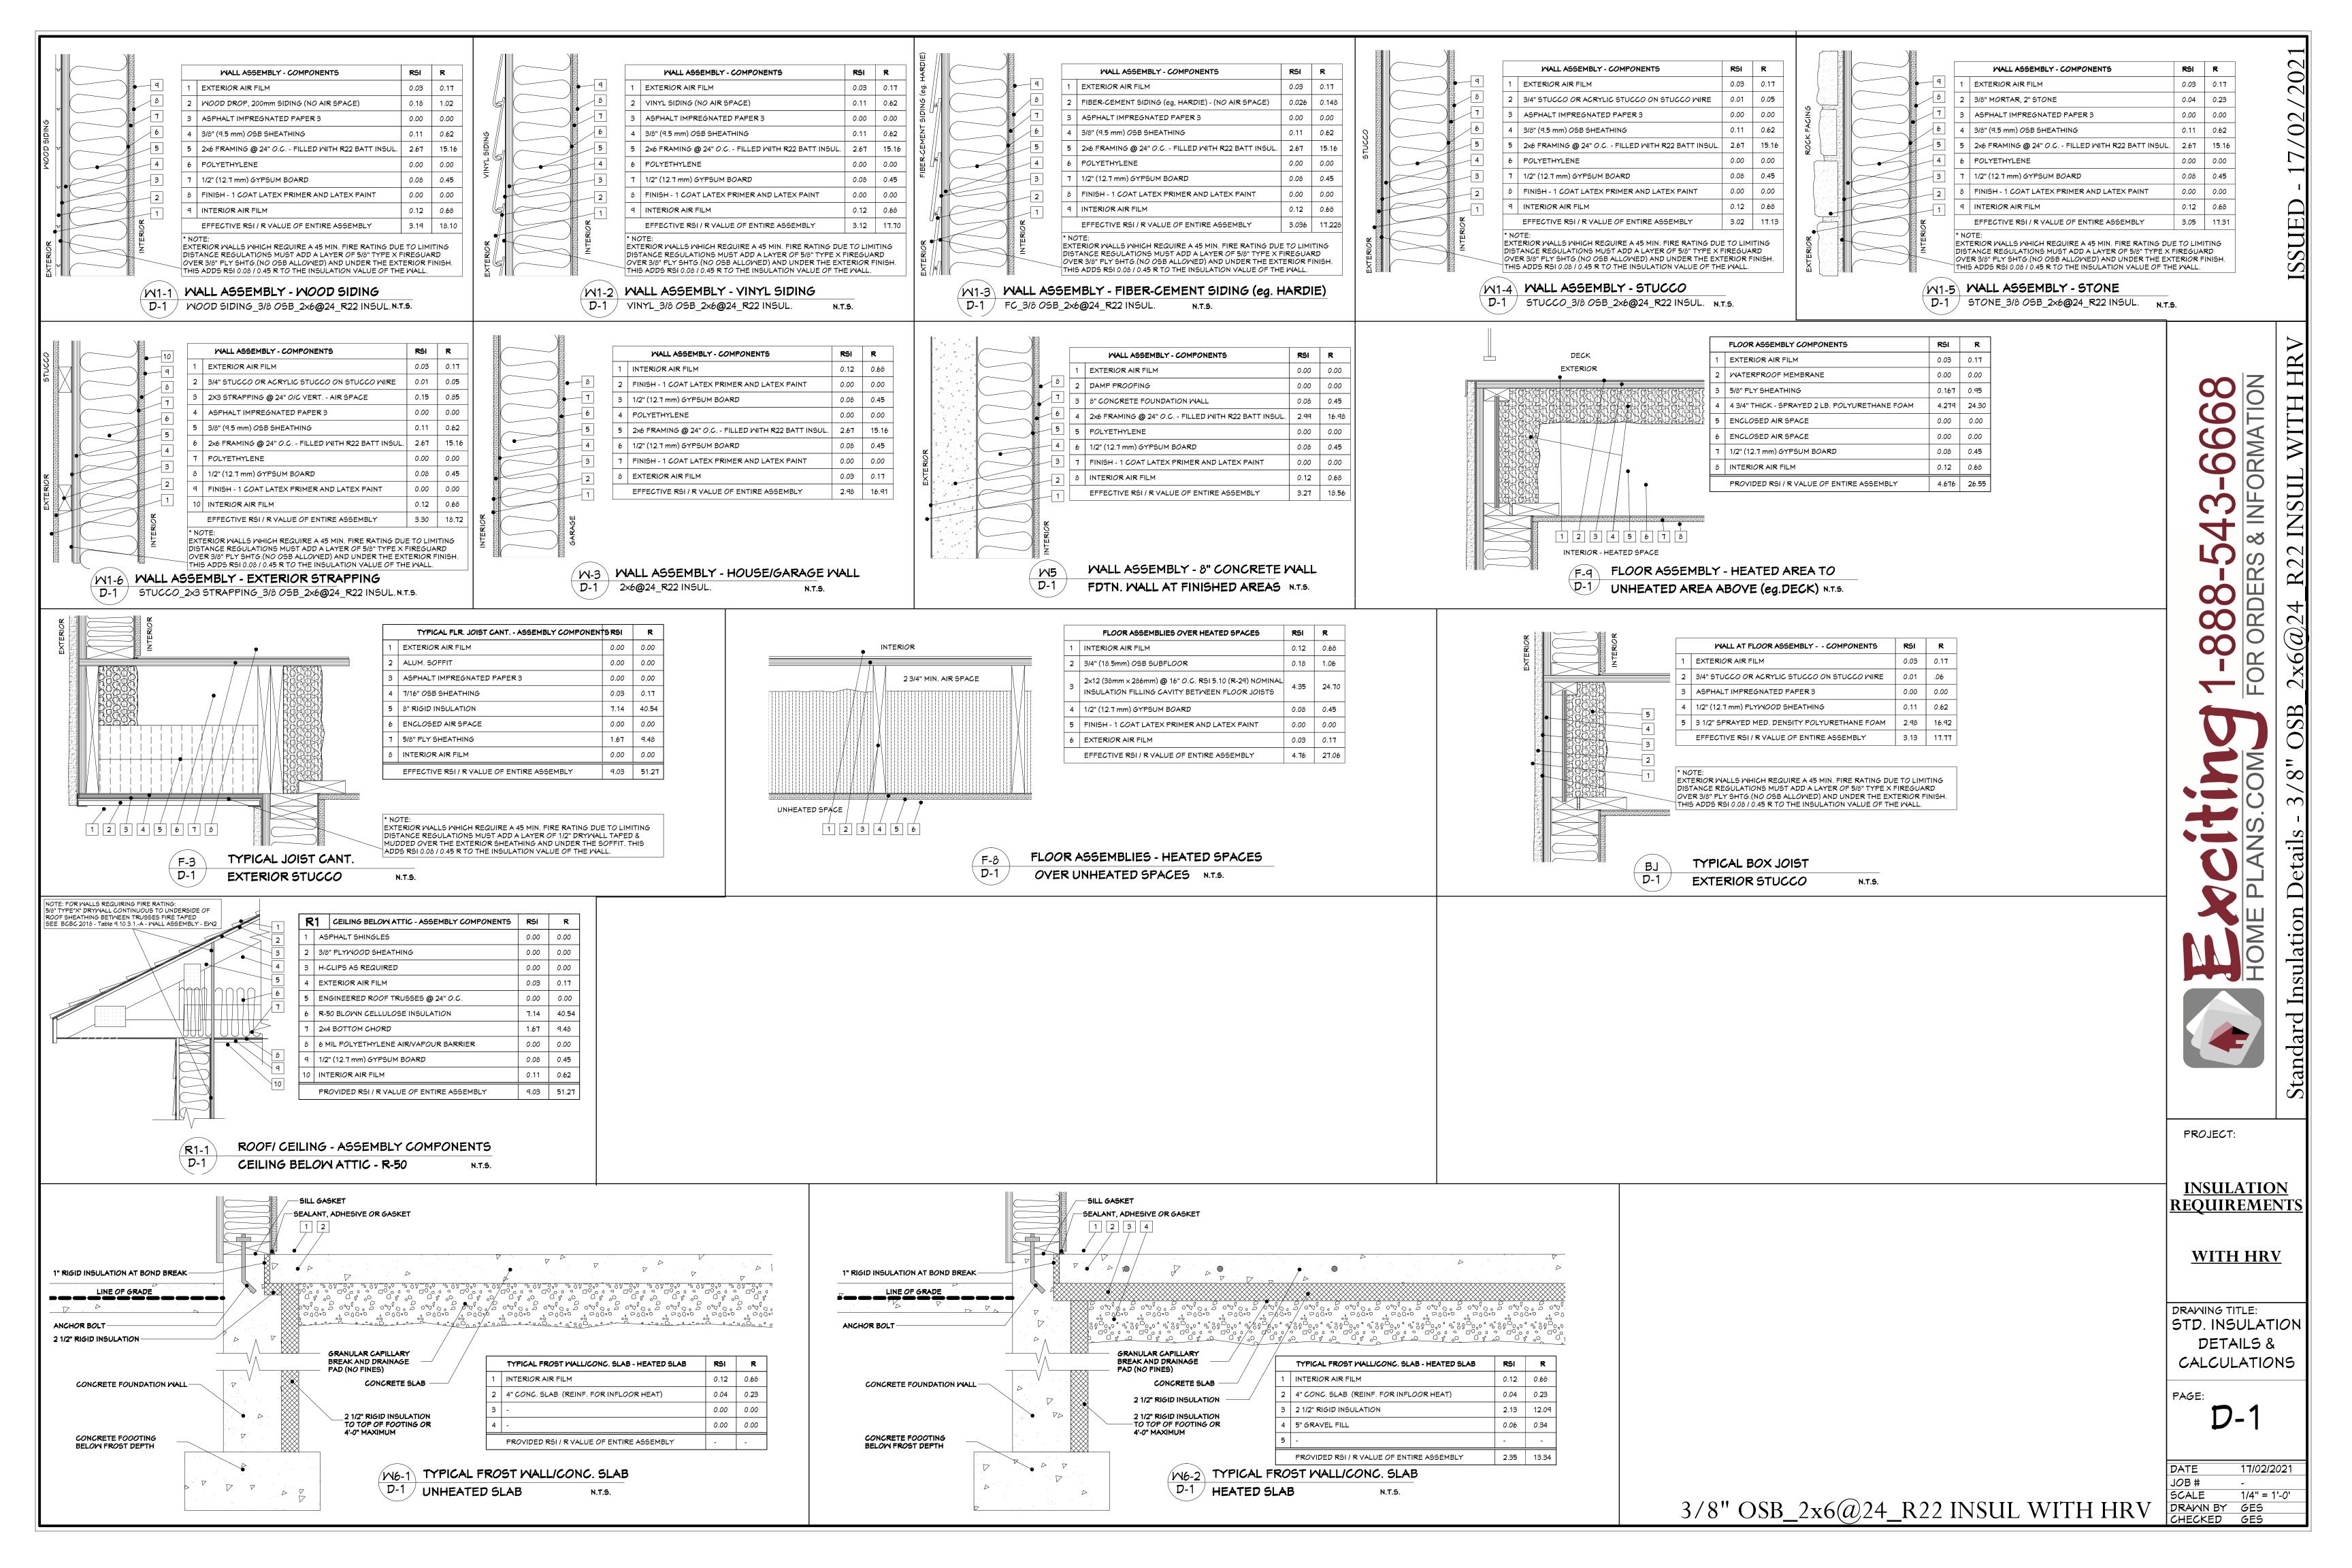
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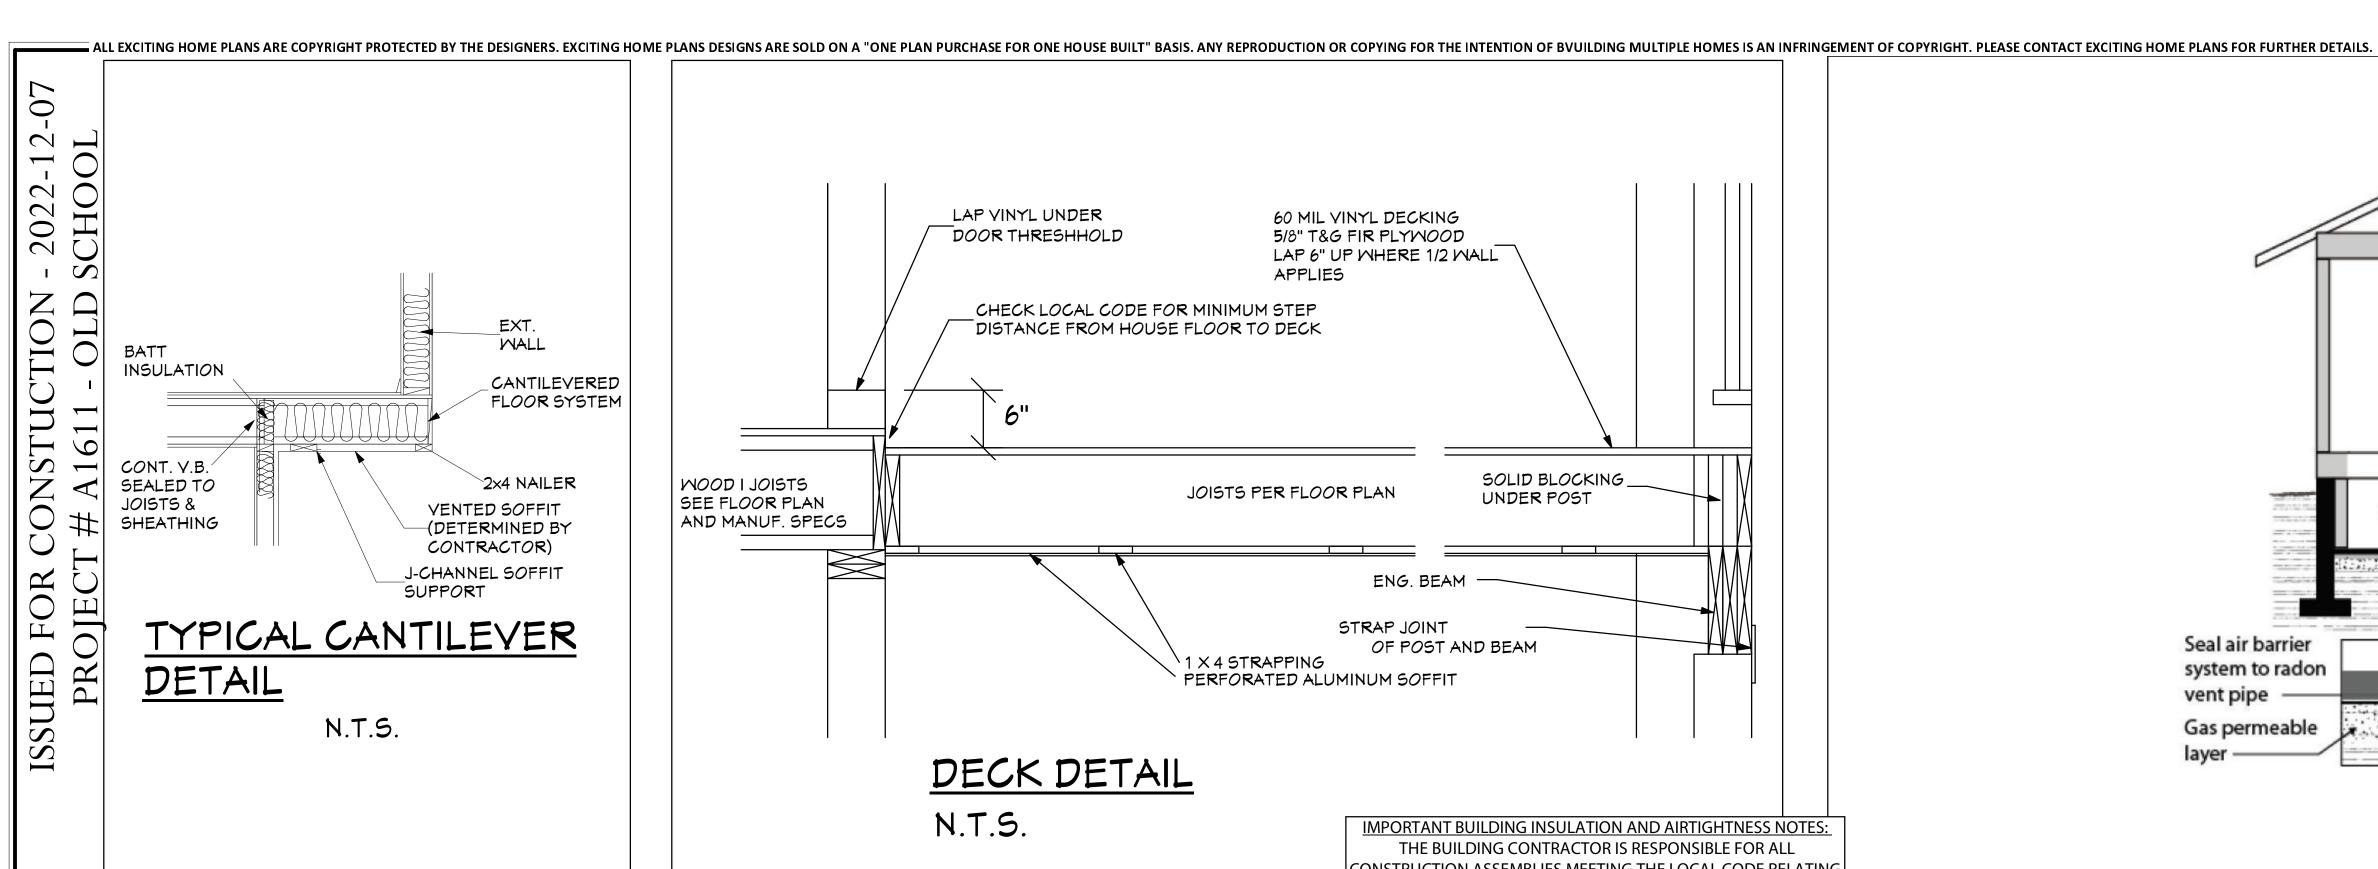
DATE 2022-12-07

JOB # 
SCALE 1/4" = 1'-0'

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CHECKED GES





45# PERFORATED

44"AROUND PERIMETER FOR EAVE PROTECTION

DETAIL

N.T.S.

EAVE FLASHING

YENTED ALUM. SOFFIT

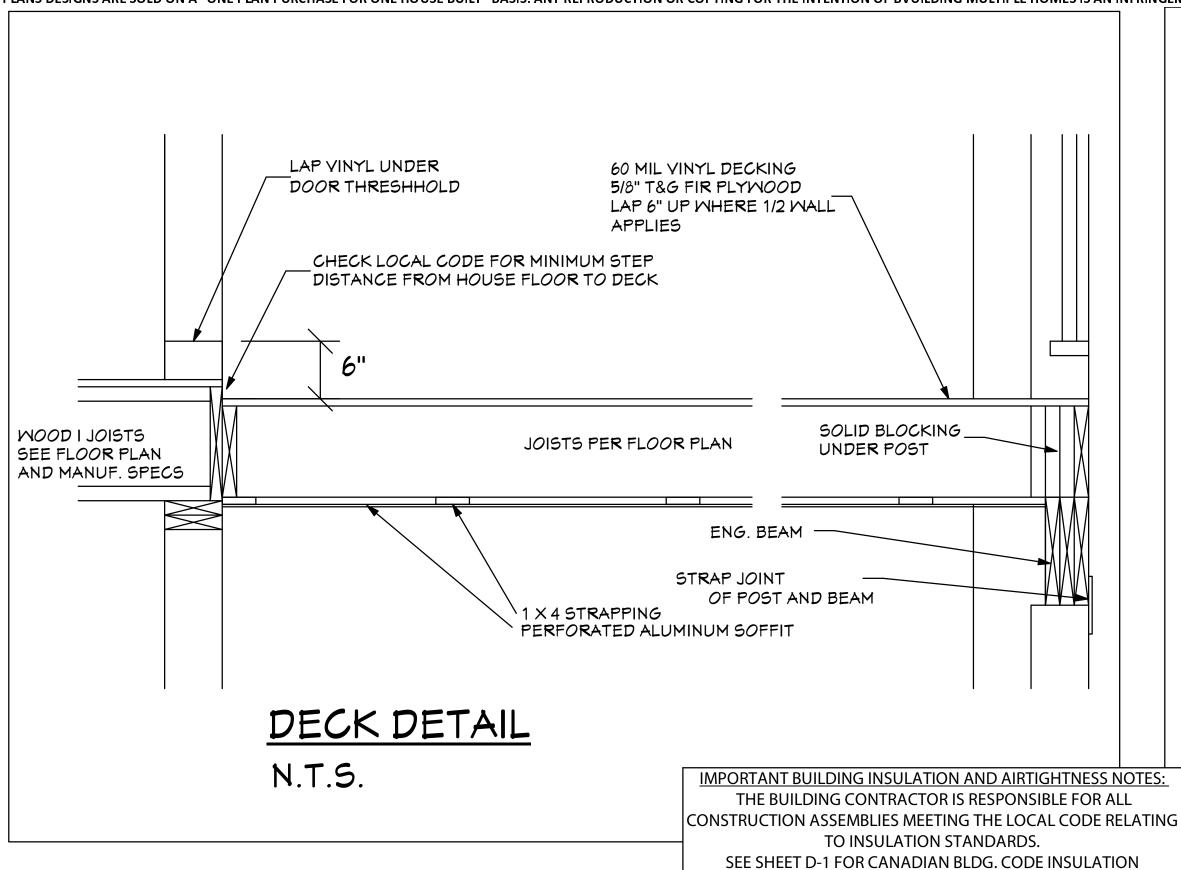
J-CHANNEL SOFFIT

TYPICAL SOFFIT

ROOFING FELT

5" PRE. FIN. ALUM. GUTTER ON

6" PRE. FIN. ALUM. FASCIA COVER ON 2x6 FASCIA BACKER



TOP OF FLOOR

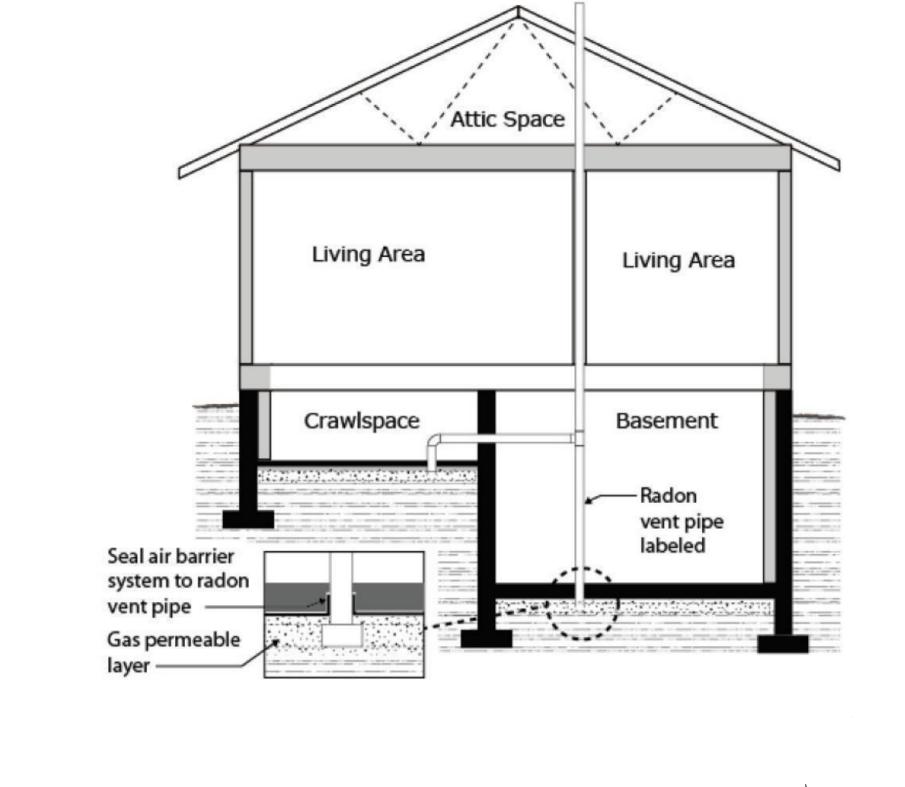
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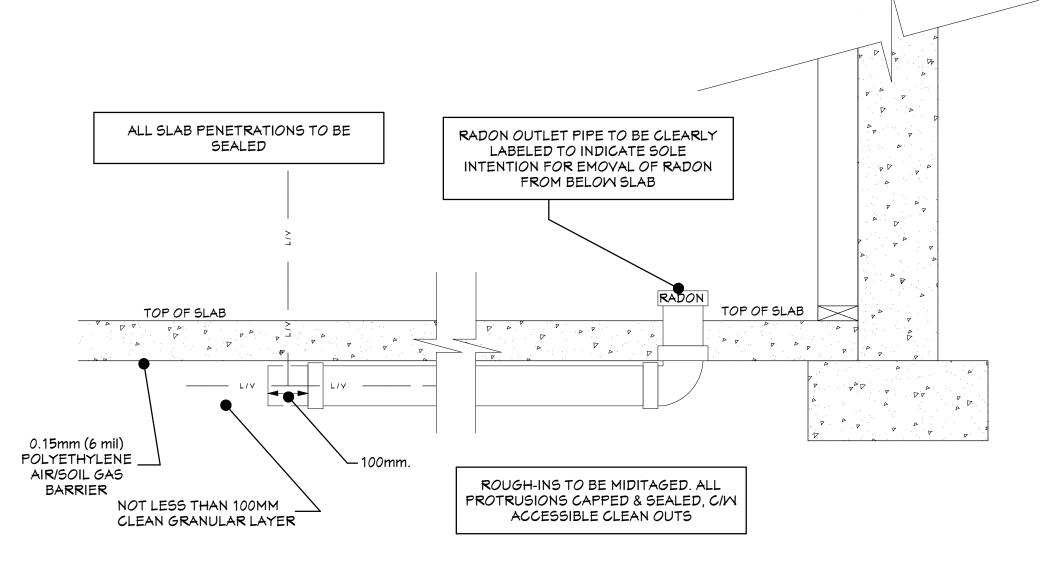
HOT AIR DUCT - (ENSURE SUFFICIENT HEIGHT)

DETAIL - PARTIALLY

EXPOSED BEAMS (N.T.S.)

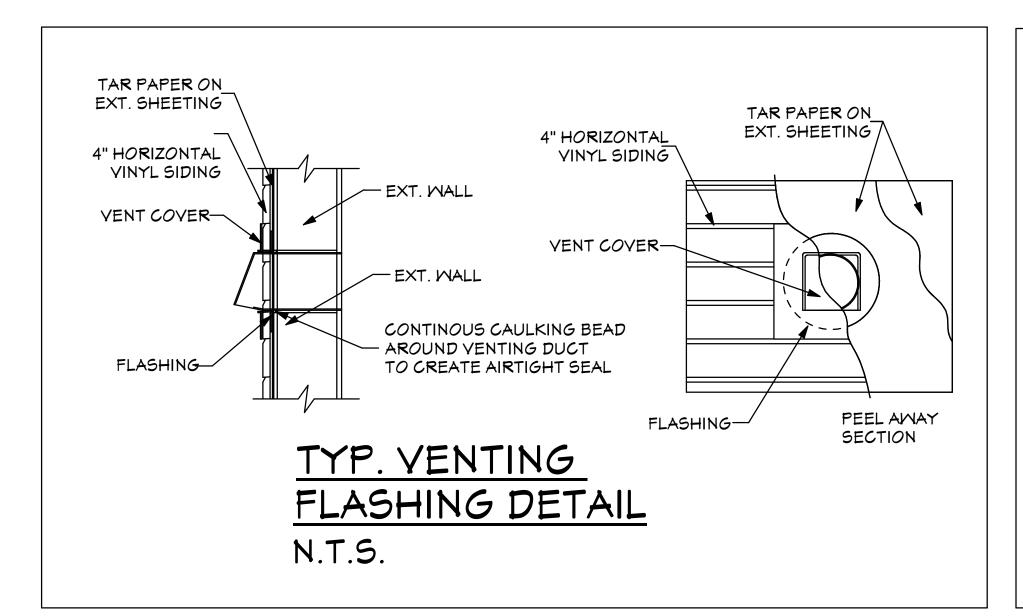
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N.T.S.

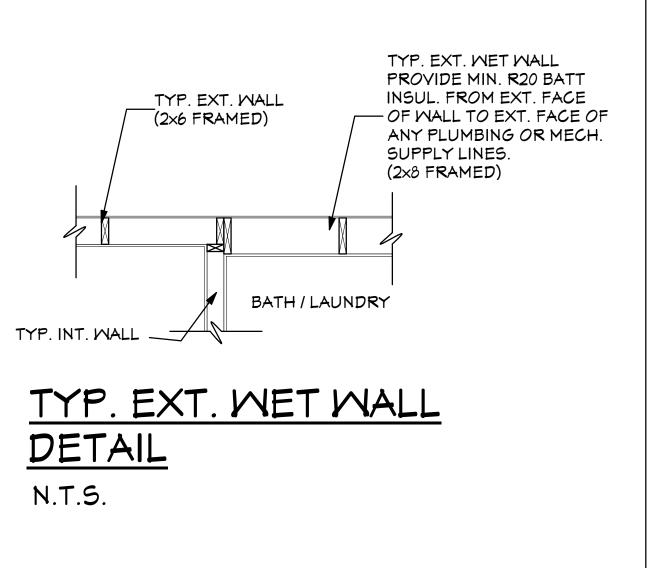


SEE X-SEC. FOR

INSULATION

- EXT. MALL

ROOF PITCH.

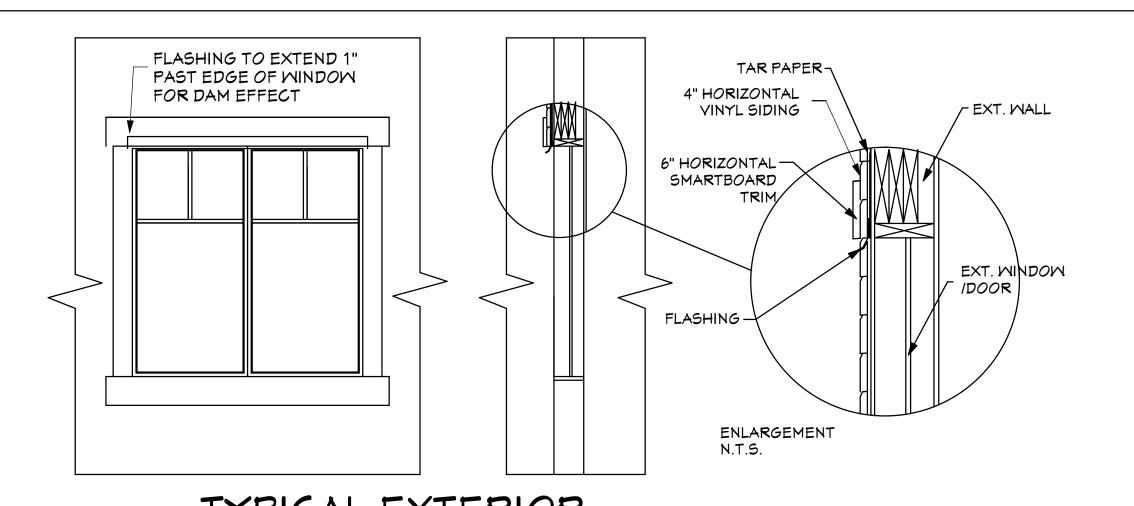


JOISTS HUNG TO SIDE OF BEAM

(REDUCING EXPOSED BEAM DEPTH)

PARTIALLY EXPOSED BEAM

SPECIFICATION OPTIONS FOR EXTERIOR WALL, FLOOR, ROOF AND FOUNDATION CONSTRUCTION ASSEMBLY DETAILS WHICH SUPERSEDE THE NOMINAL INSULATION VALUES AND ASSEMBLIES NOTED ON THIS PAGE.



TYPICAL EXTERIOR WINDOW FLASHING DETAIL N.T.S.

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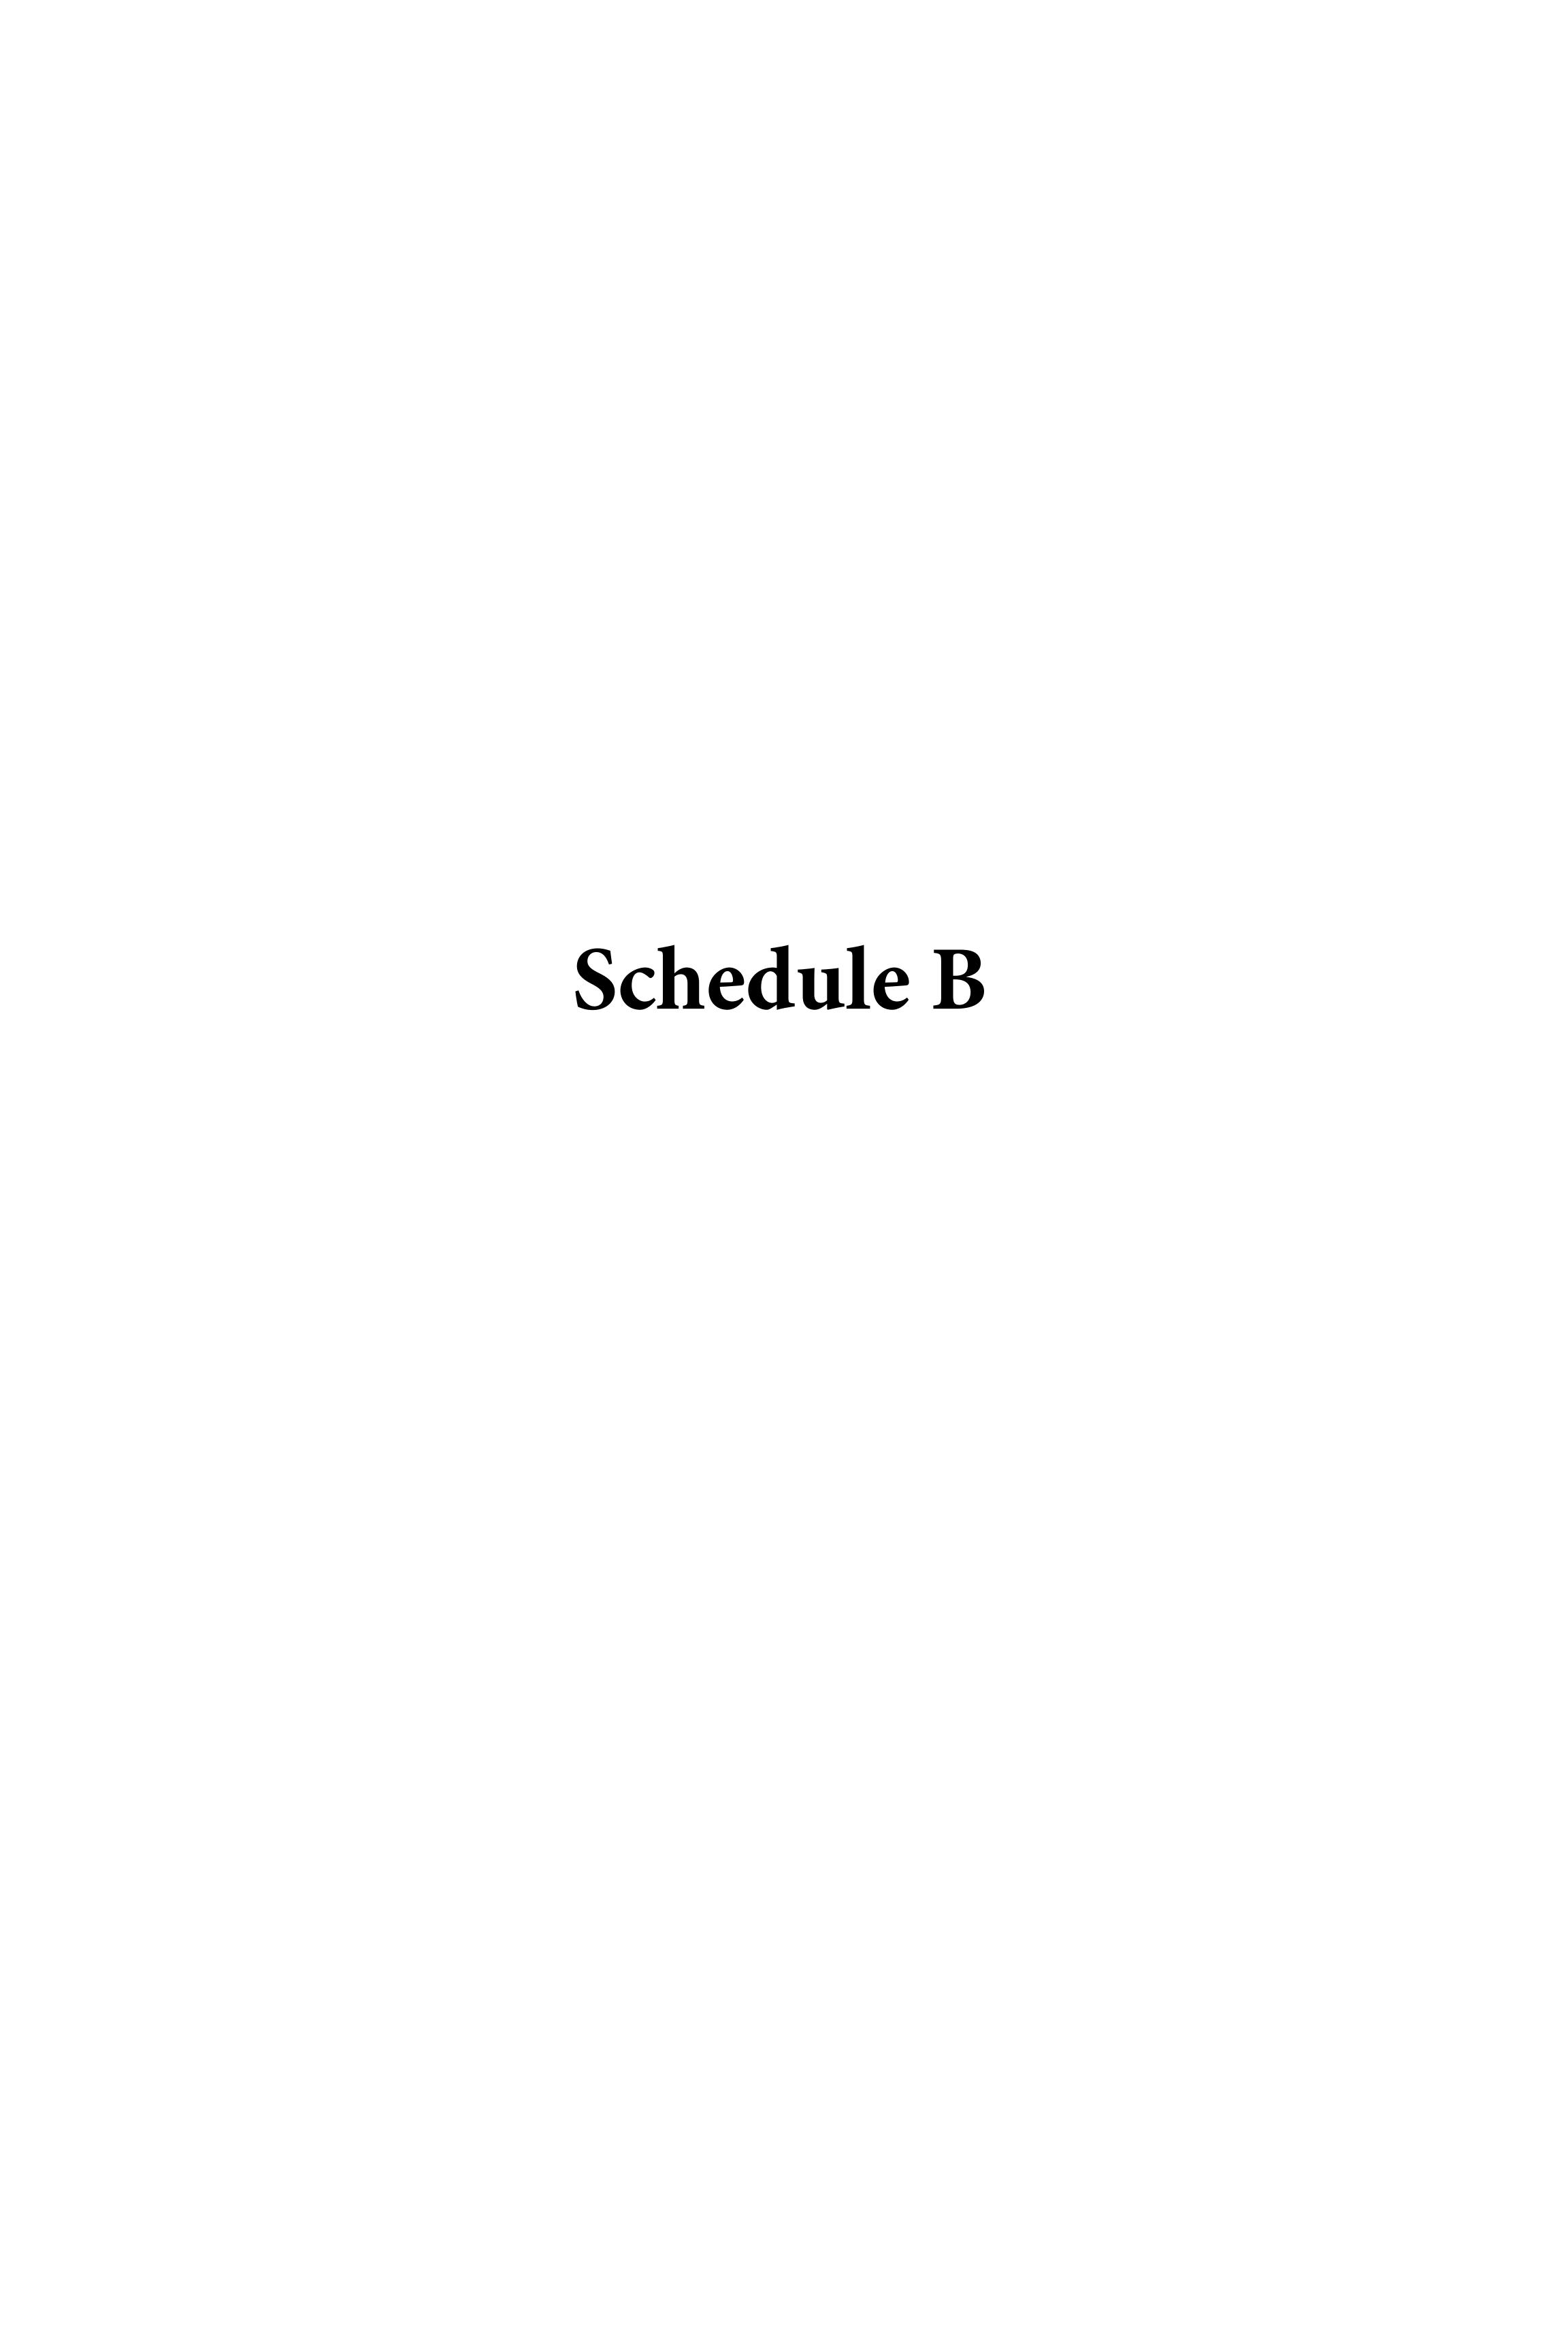
Tallus Ridge Ph. 11

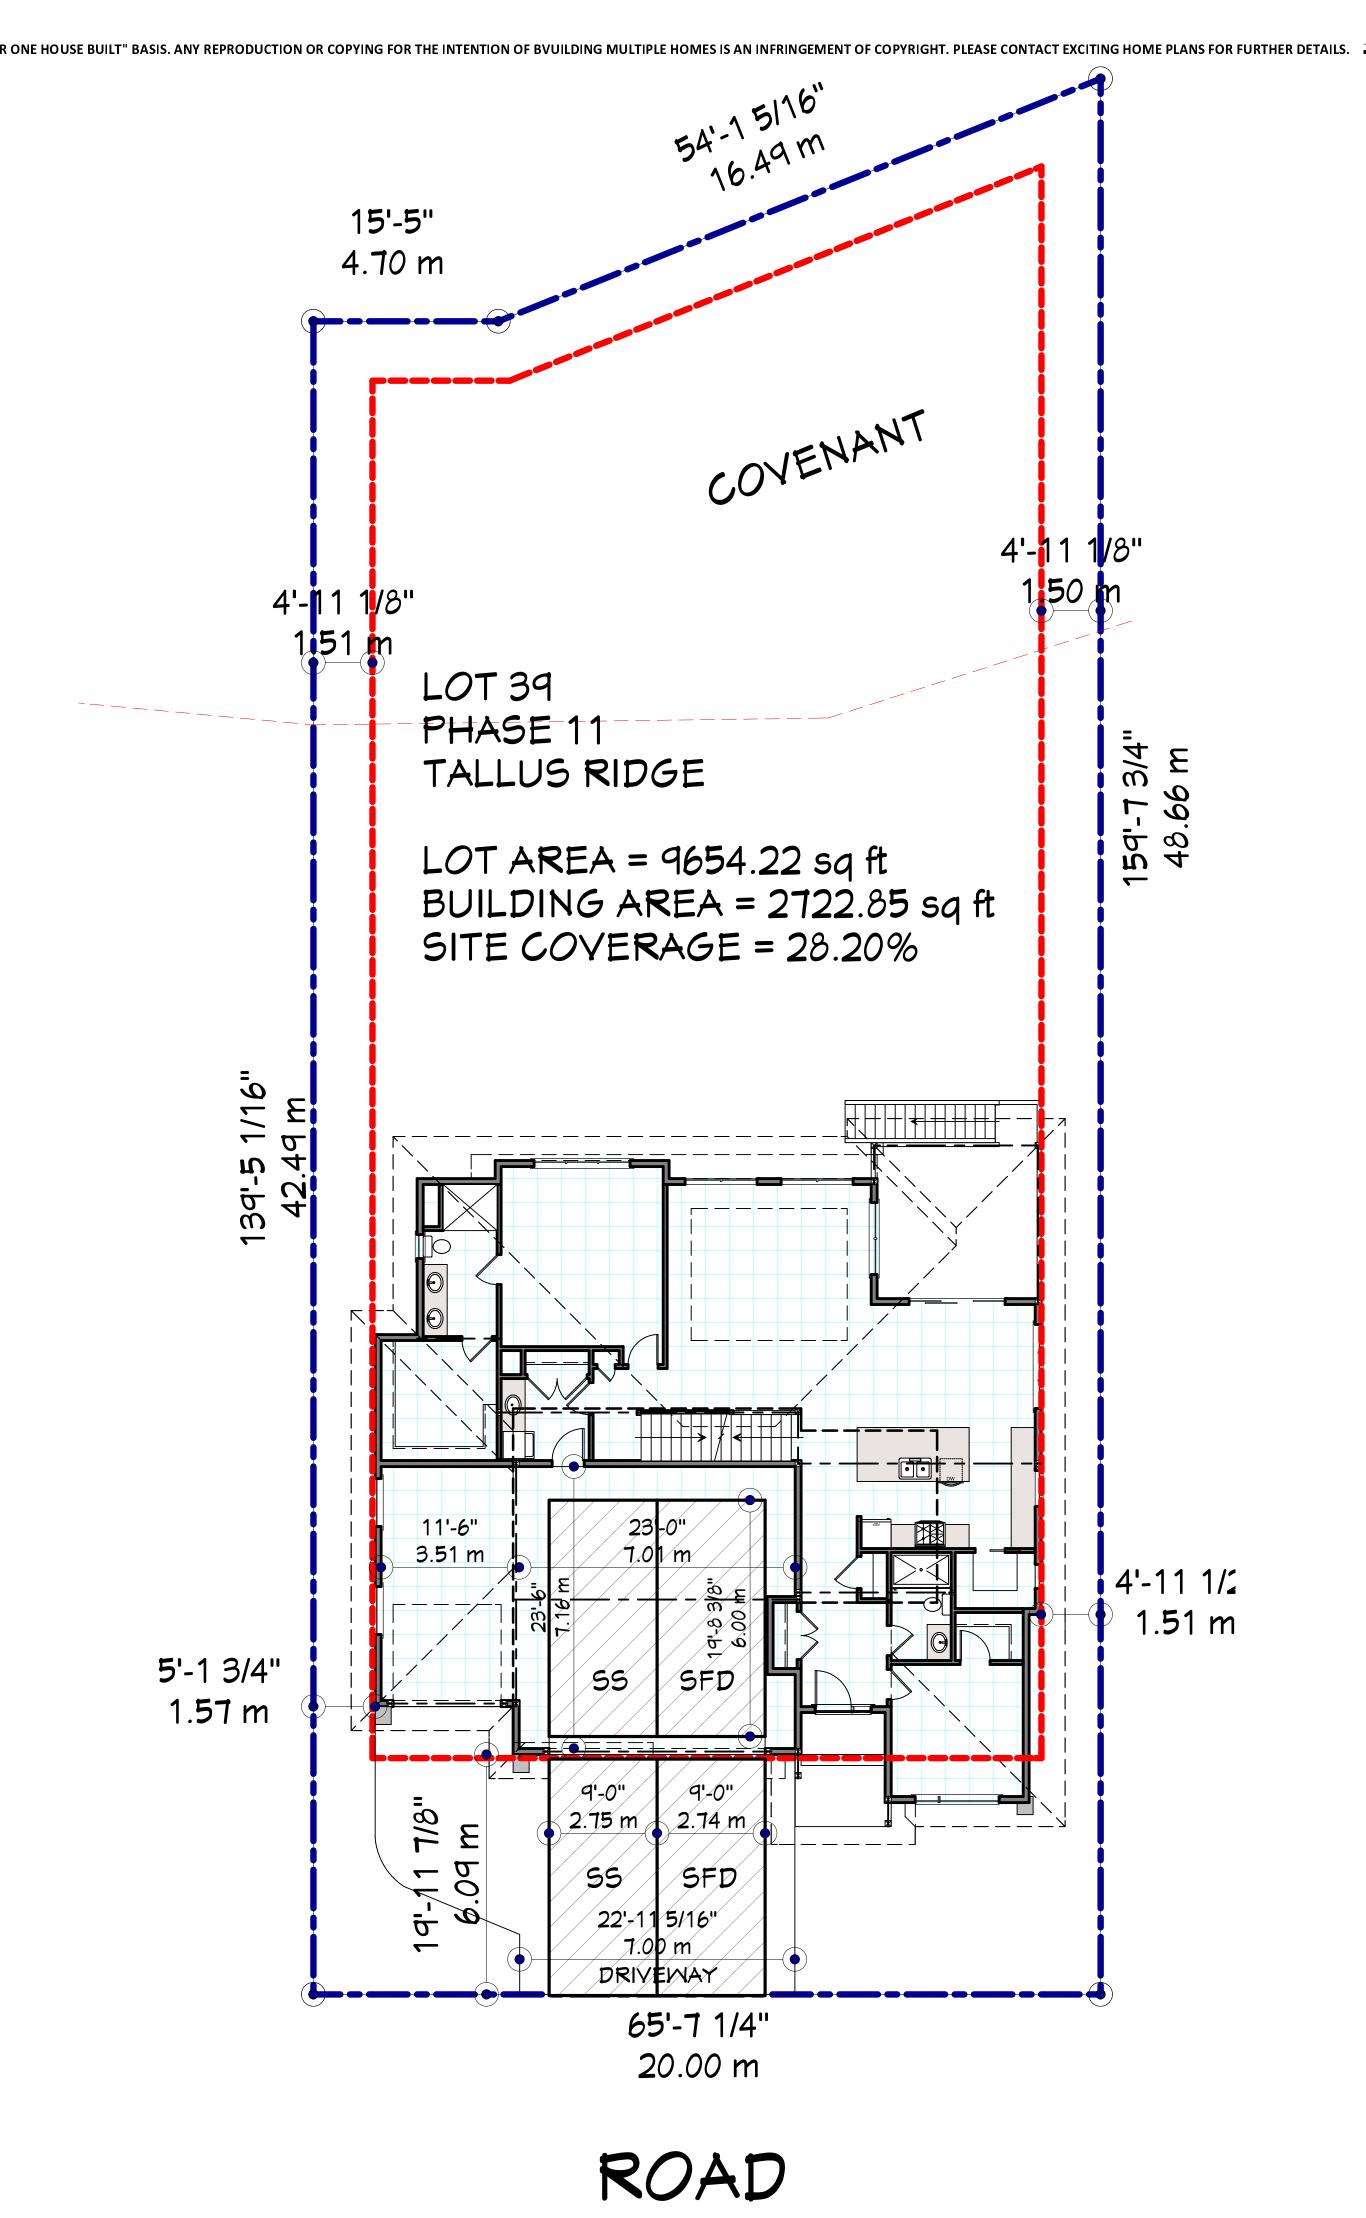
Client: The Tran Residence

DRAWING TITLE: **DETAILS** 

PAGE: D2

2022-12-07 JOB# 1/4" = 1'-0' DRAWN BY GES CHECKED GES





CITY OF WEST KELOWNA
PLANNING DEPARTMENT

SCHEDULE: 'B'

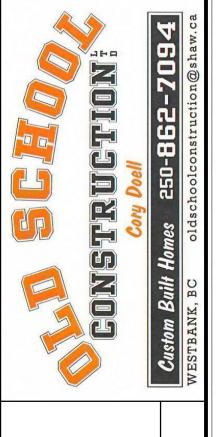
FILE NO.: DVP 23-08



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IT IS THE BUILDERS
RESPONSIBILITY TO VERIFY ALI
DIMENSIONS ON SITE PRIOR TO
COMMENCEMENT OF WORK.
WRITTEN DIMENSIONS TAKE
PRECEDENCE. DO NOT SCALE
DRAWING.

REV.#	DATE:
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Lot 39 Tallus Ridge Ph. 11

Client: The Tran Residence

DRAWING TITLE:
SITE PLAN

PAGE:

S1

DATE 2023-08-30

JOB # 
SCALE 1/4" = 1'-0'

DRAWN BY GES

CHECKED GES